



Native Seed Mix Information

(HYDROSEED application or approved equal)

The specified seed mix(es) should be applied at a rate of 22-25 kg/ha or at a rate of 125 g/45 m²

S1 for smaller areas.

ANNUAL RYE NURSE CROP

(OSC 7115 or approved equal)

• A cover crop should be utilized with each of the seed mixes. The cover crop will act as a nurse crop, provide short term erosion control and weed control. • The cover crop should be applied at a <u>maximum</u> rate of 20 kg/ha and should be mixed with the

proposed seed blend for a single application. • Mix annual rye with the proposed native seed mixes to provide quick germination and help reduce weed seed germination, stop soil from blowing away and reduce erosion damage from run-off. NOTE: do not over apply annual rye when using it as a nurse crop.

Installations Notes:

• Ideally, sowing should take place in the fall, between Oct 15th to late November. An early spring sowing will work but not as effectively. If moisture is not present, some of the seed may go dormant and not germinate until the following spring. Whenever possible, work up the soil a little to ensure good seed-to-soil contact for improved germination. Call OSC Ltd for more information: 519-886-0557.

• In general, a minimum of 15 cm of topsoil should be applied to disturbed areas prior to Hydroseeding applications.

• All disturbed areas should be seeded as soon as possible following the completion of works. Erosion controls must remain in place until seeding has sufficiently stabilized the site (i.e. more • Seeding should not be executed during the drought-prone season (i.e. June through August),

unless adequate irrigation can be supplied. • Survey site for invasive species & remove. Clean away surface debris. This increases sunlight penetration to the soil surface and eases sowing. Lightly cultivate soil to accept seed and improve

• Make sure the soil and seed are in close contact by gently tamping or rolling the seedbed. Do not compact. Excessive force will destroy soil structure and inhibit germination.

CVC 2 - Naturalized Wetland Meadow Mix*

Bebb's Sedge Carex bebbi Eupatorium perfoliatum 1% Boneset 25% Fowl Bluegrass Poa palustris Fox Sedge Carex vulpinoidea 40% Dark Green Bulrush Scirpus atrovirens Nodding Bur Marigold Bidens cernua Purple Stemmed Aster Aster puniceus Rice Cutgrass Leersia oryzoides Soft Rush Juncus effusus Spotted Joe Pye Weed Eupatorium maculatum 1% Stalk-grain Sedge Carex stipata Swamp Milkweed Asclepias incarnata Tall Mannagrass Glyceria grandis

*Note: Developed by OSC (Ontario Seed Company)


CVC 7 - Upland Native Meadow Mix*

S2


Aster cordifolius Heart Leaved Aster Canada Anemone Anemone canadensis Canada Goldenrod Solidago canadensis Common Milkweed Asclepias syriaca Evening Primrose Oenethera biennis Grass Leaved Goldenrod Euthamia graminifolia Meadow Sedge Carex granularis New England Aster Aster novae-angliae Riverbank Wild Rye Elymus riparius Virgins Bower Clematis virginiana Monarda fistulosa Wild Bergamot

*Note: Developed by OSC (Ontario Seed Company)

Legend

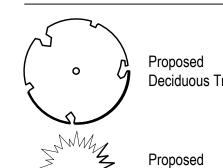

Deciduous Tree

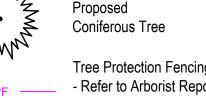

Tree Protection Fencing - Refer to Arborist Report & TIPP Prepared by

——— — Property Line Prop. 1.8m HT Wood Privacy Fence Typ.

Kuntz Forestry

Ornamental Fence Typ. Prop. Sodded


Area Typ.


Prop. Concrete Paving Typ.

by Kuntz Forestry


Prop. Unit Paving Type 1

Proposed Planting Area

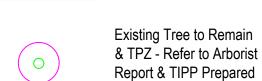

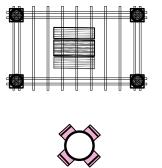

5 Gal. High Yes Full Form (PPOY Winner)

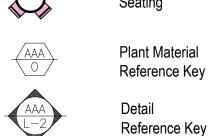

Proposed Bench

Proposed Pergola

and Seating

Proposed Plant Material List

KEY	QNTY	BOTANICAL NAME	COMMON NAME	HT/CAL	SPREAD	ROOT	DROUGHT TOLERANT	NATIVE	REMARKS
DECIDUO	US TREE	S	•	•					
AXF	13	Acer x freemanii 'Jeffersred'	Jeffersred Freeman Maple	70 mm		В.&В.	High	Yes	Full Form
CEH	10	Celtis occidentalis	Hackberry	70 mm		В.&В.	High	Yes	Full Form
GSS	10	Gleditsia triacanthos 'Shademaster'	Shademaster Honey-Locust	70 mm		B.&B.	High	Yes	Full Form
TAM	8	Tilia Americana	Basswood Linden	70 mm		В.&В.	Hìgh	Yes	Full Form
QRB	6	Quercus rubra	Red Dak	70 mm		В.&В.	High	Yes	Full Form
CONIFER	OUS TRE	EES	·	•					
PGL	11	Picea glauca	White Spruce	200 cm		В.&В.	High	Yes	Full Form
PSB	16	Pinus strobus	White Pine	200 cm		B.&B.	High	Yes	Full Form
SPECIME	N	•	•	•	•				
ACB	4	Amelancier canadensis 'Ballerina'	Ballerina Serviceberry	200 cm		В.&В.	Hìgh	Yes	Multi Stem
CAL	6	Cornus alternifolia	Pagoda Dogwood	120 cm		В.&В.	High	Yes	Full Form
DECIDUO	US SHRU	JBS	•	•					
CNK	177	Cornus sericea 'Kelseyi'	Kelsey Red Osier Dogwood	60 cm		C.G.	High	Yes	Full Form
SJL	363	Spirea japonica 'Little Princess'	Dwarf Red Spirea	60 cm		C.G.	High	Yes	Full Form
PFG	338	Potentilla frut Goldfinger	Goldfinger	60 cm		C.G.	High	Yes	Full Form
POD	44	Physocarpus opulifolius 'Dart's Gold'	Dart's Gold Ninebark	60 cm		C.G.	High	Yes	Dwarf
SBG	257	Spirea bumalda 'Gold Mound'	Gold Mound Spirea	60 cm		C.G.	High	Yes	Full Form
CONIFER	ROUS SHE	RUBS	,	•					
TCF	137	Taxus cuspidata 'Fairview'	Fairview Yew		65 cm	C.G.	High	Yes	Full Form
PERENNI	IALS			•					
GER	228	Geranium maculatum	Wild Geranium			2 Gal.	No	Yes	White Flowers
HSD	356	Hemerocallis 'Stella D'oro'	Stella D'oro (Yellow) Daylilies			2 Gal.	Yes	No	Full Form
PAT	134	Perovskia atriplicifolia	Russian Sage			2 Gal.	High	Yes	Full Form (PPOY Winner)
SAM	194	Salvia x sylvestris 'May Night'	May Night Salvia			2 Gal.	Yes	No	Full Form

Karl Foerster Feather Reed Grass



170 The Donway W Suite 206. Toronto, Ontario, Canada. M3C 2G3

tel. 416.492.9966 | email. info@msla.ca

Architect:

Client/Owner:





09 Issued for Submission Issued for Coordination 07 Issued for Coordination 06 Issued for Submission 09/09/24 05 Issued for Coordination Issued for Re-Submission 03 Issued for Submission 09/08/23 02 Issued for Coordination 06/26/23 01 Issued for Coordination No. Revision




Residential Apartment


20 Cairns Crescent, Huntsville,

1:400 Date: **MAR 2023** A.L. Checked By: L.M. Drawing Title:


Landscape **Master Plan**

Project No. 23116

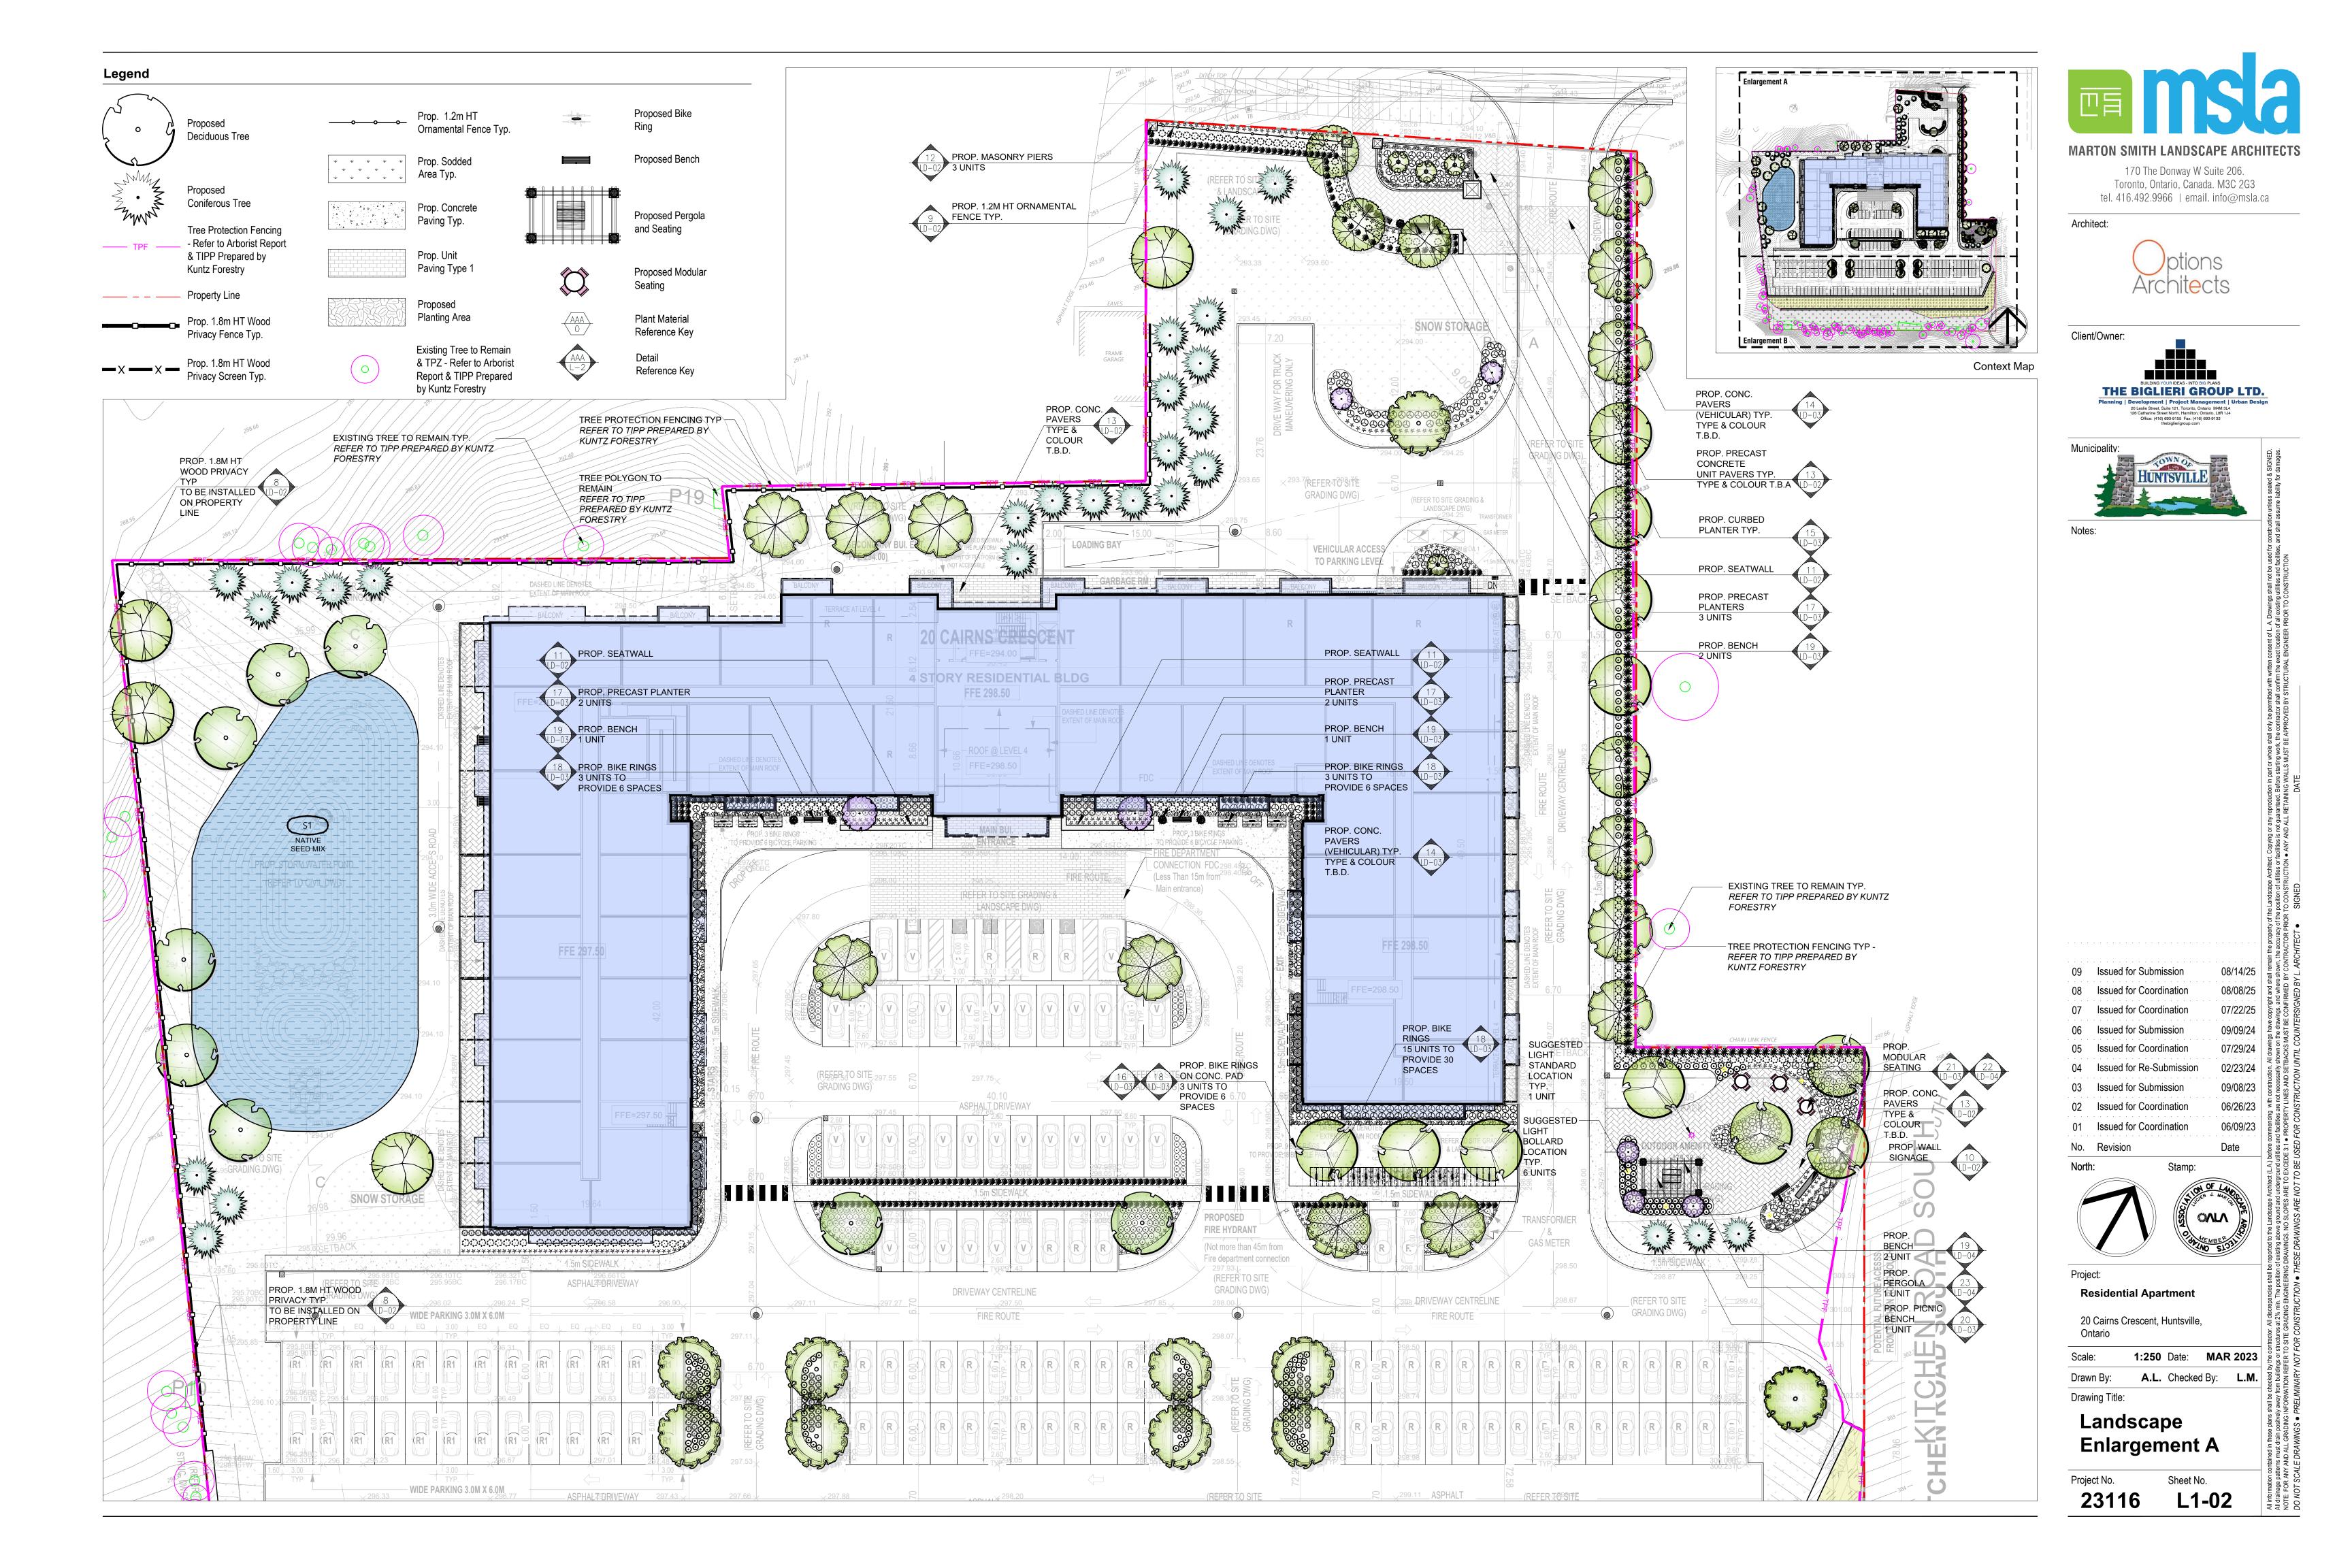

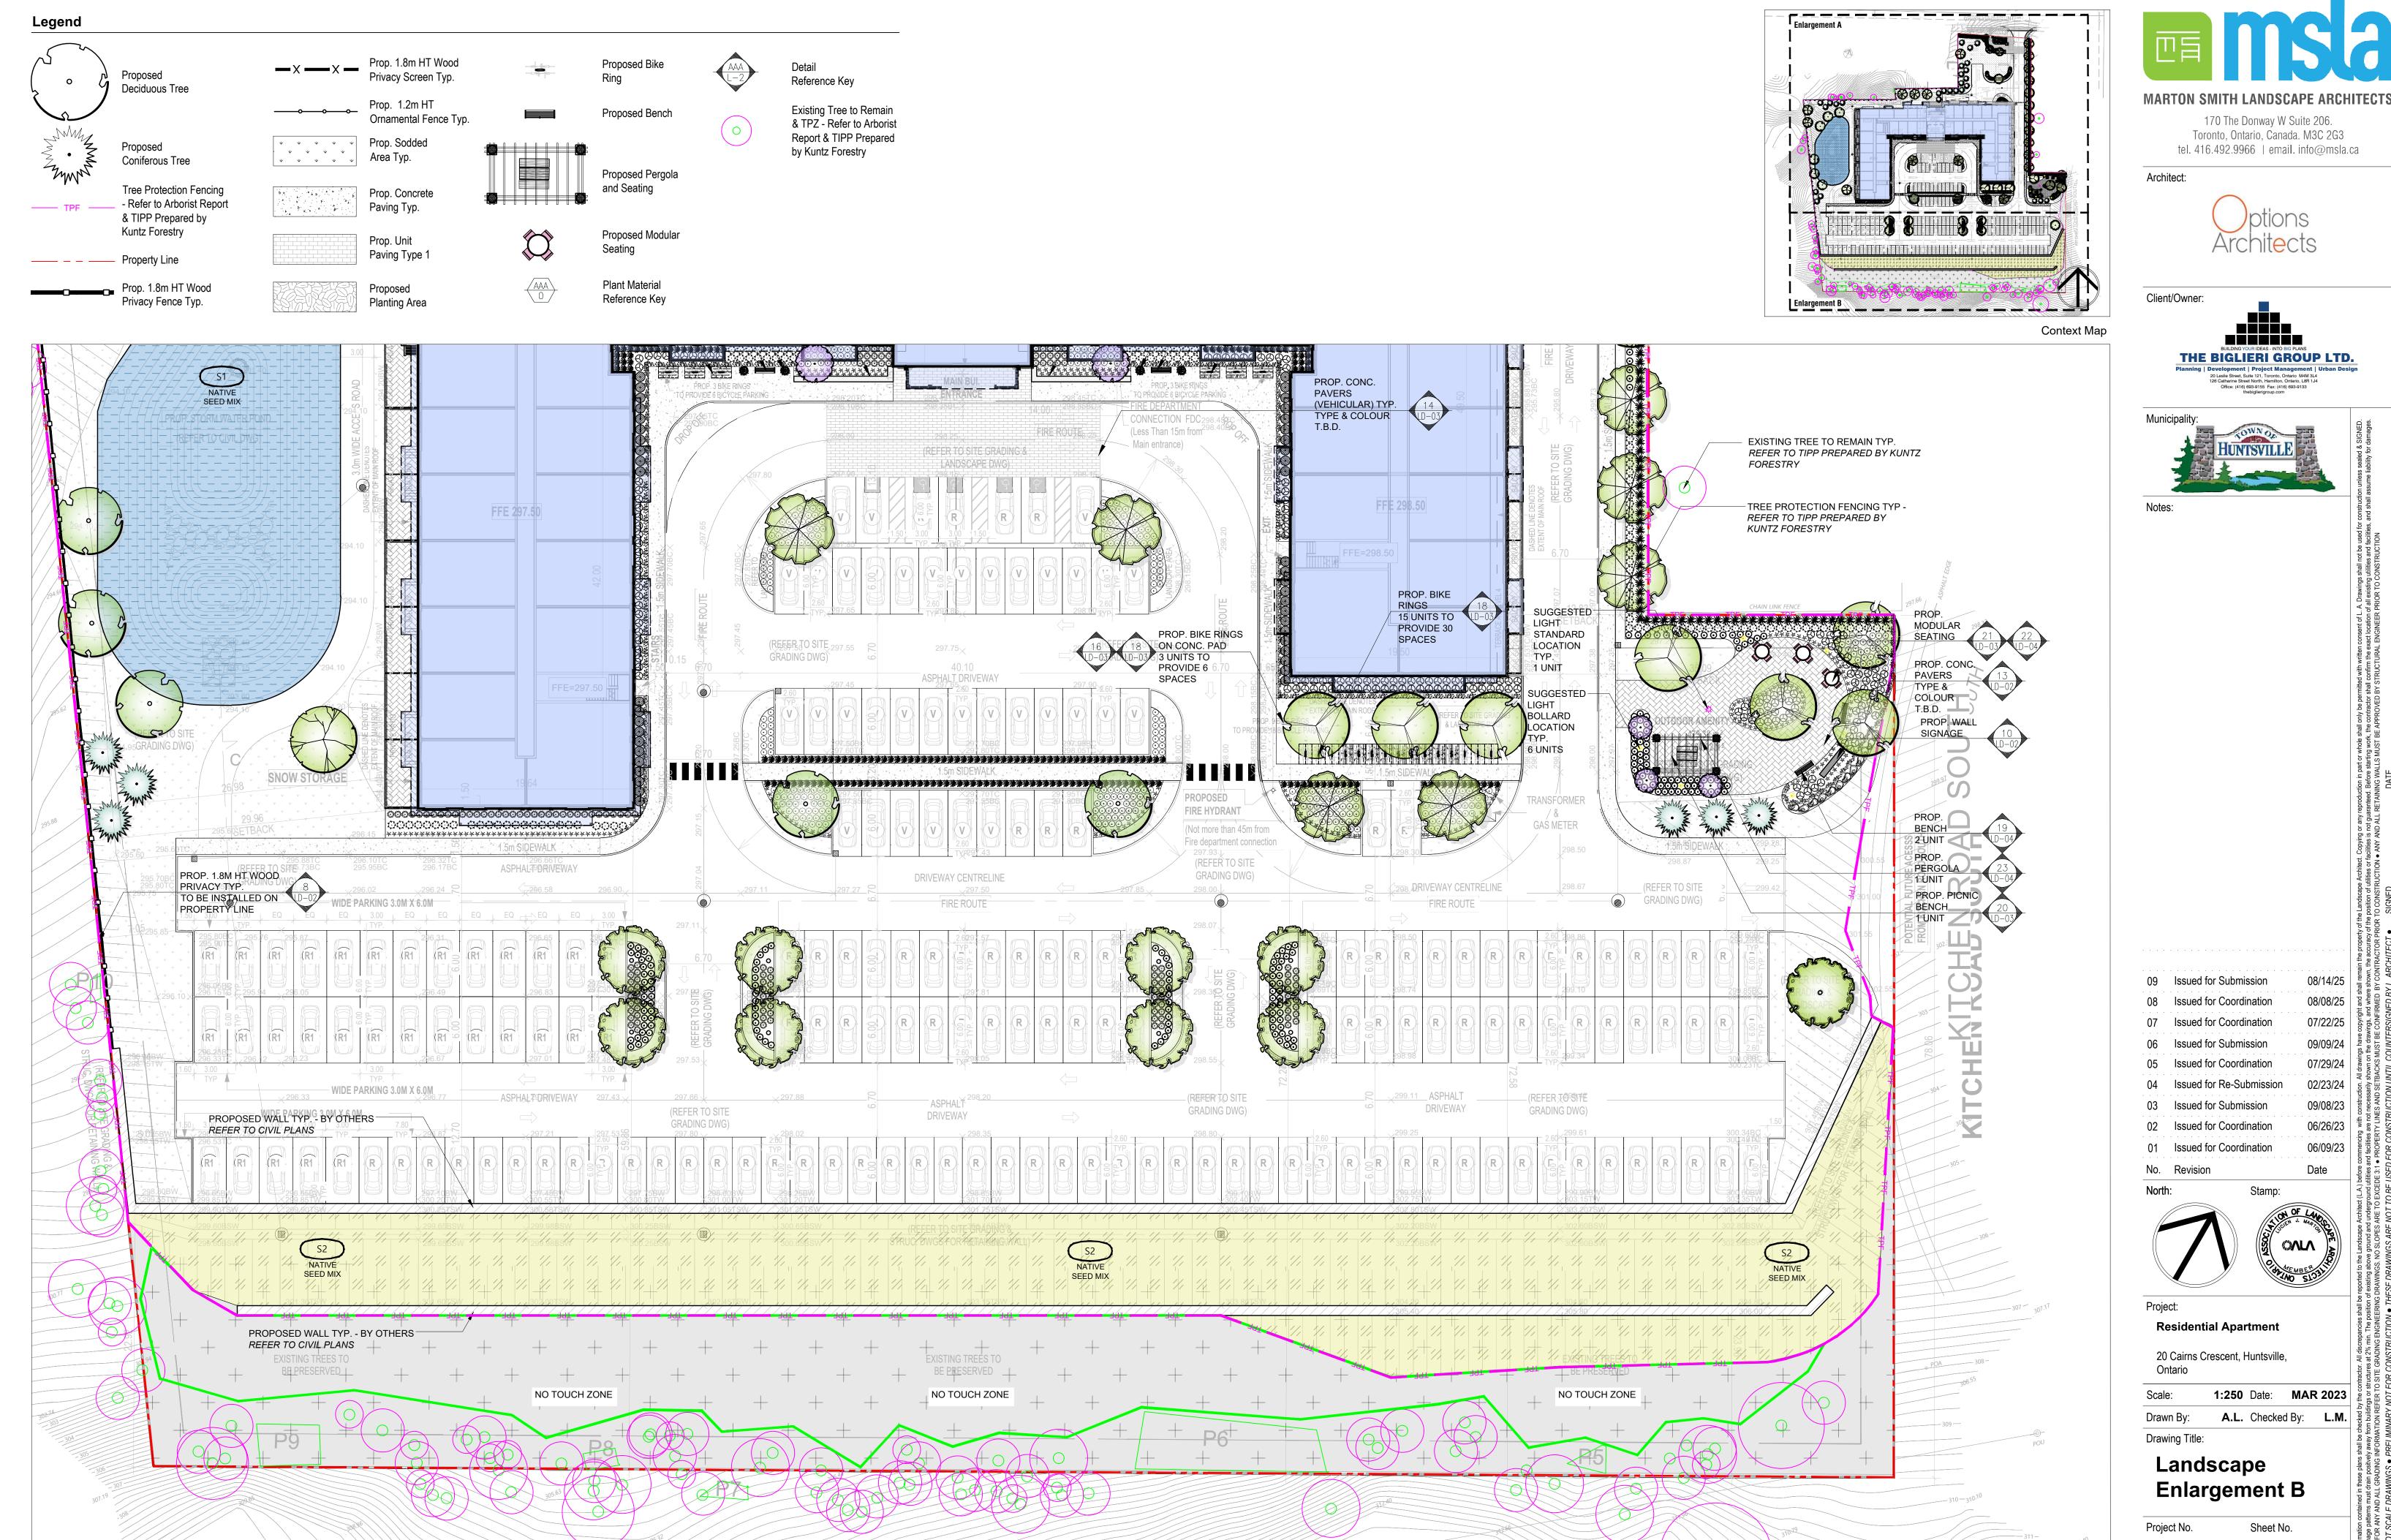

23116 L1-03

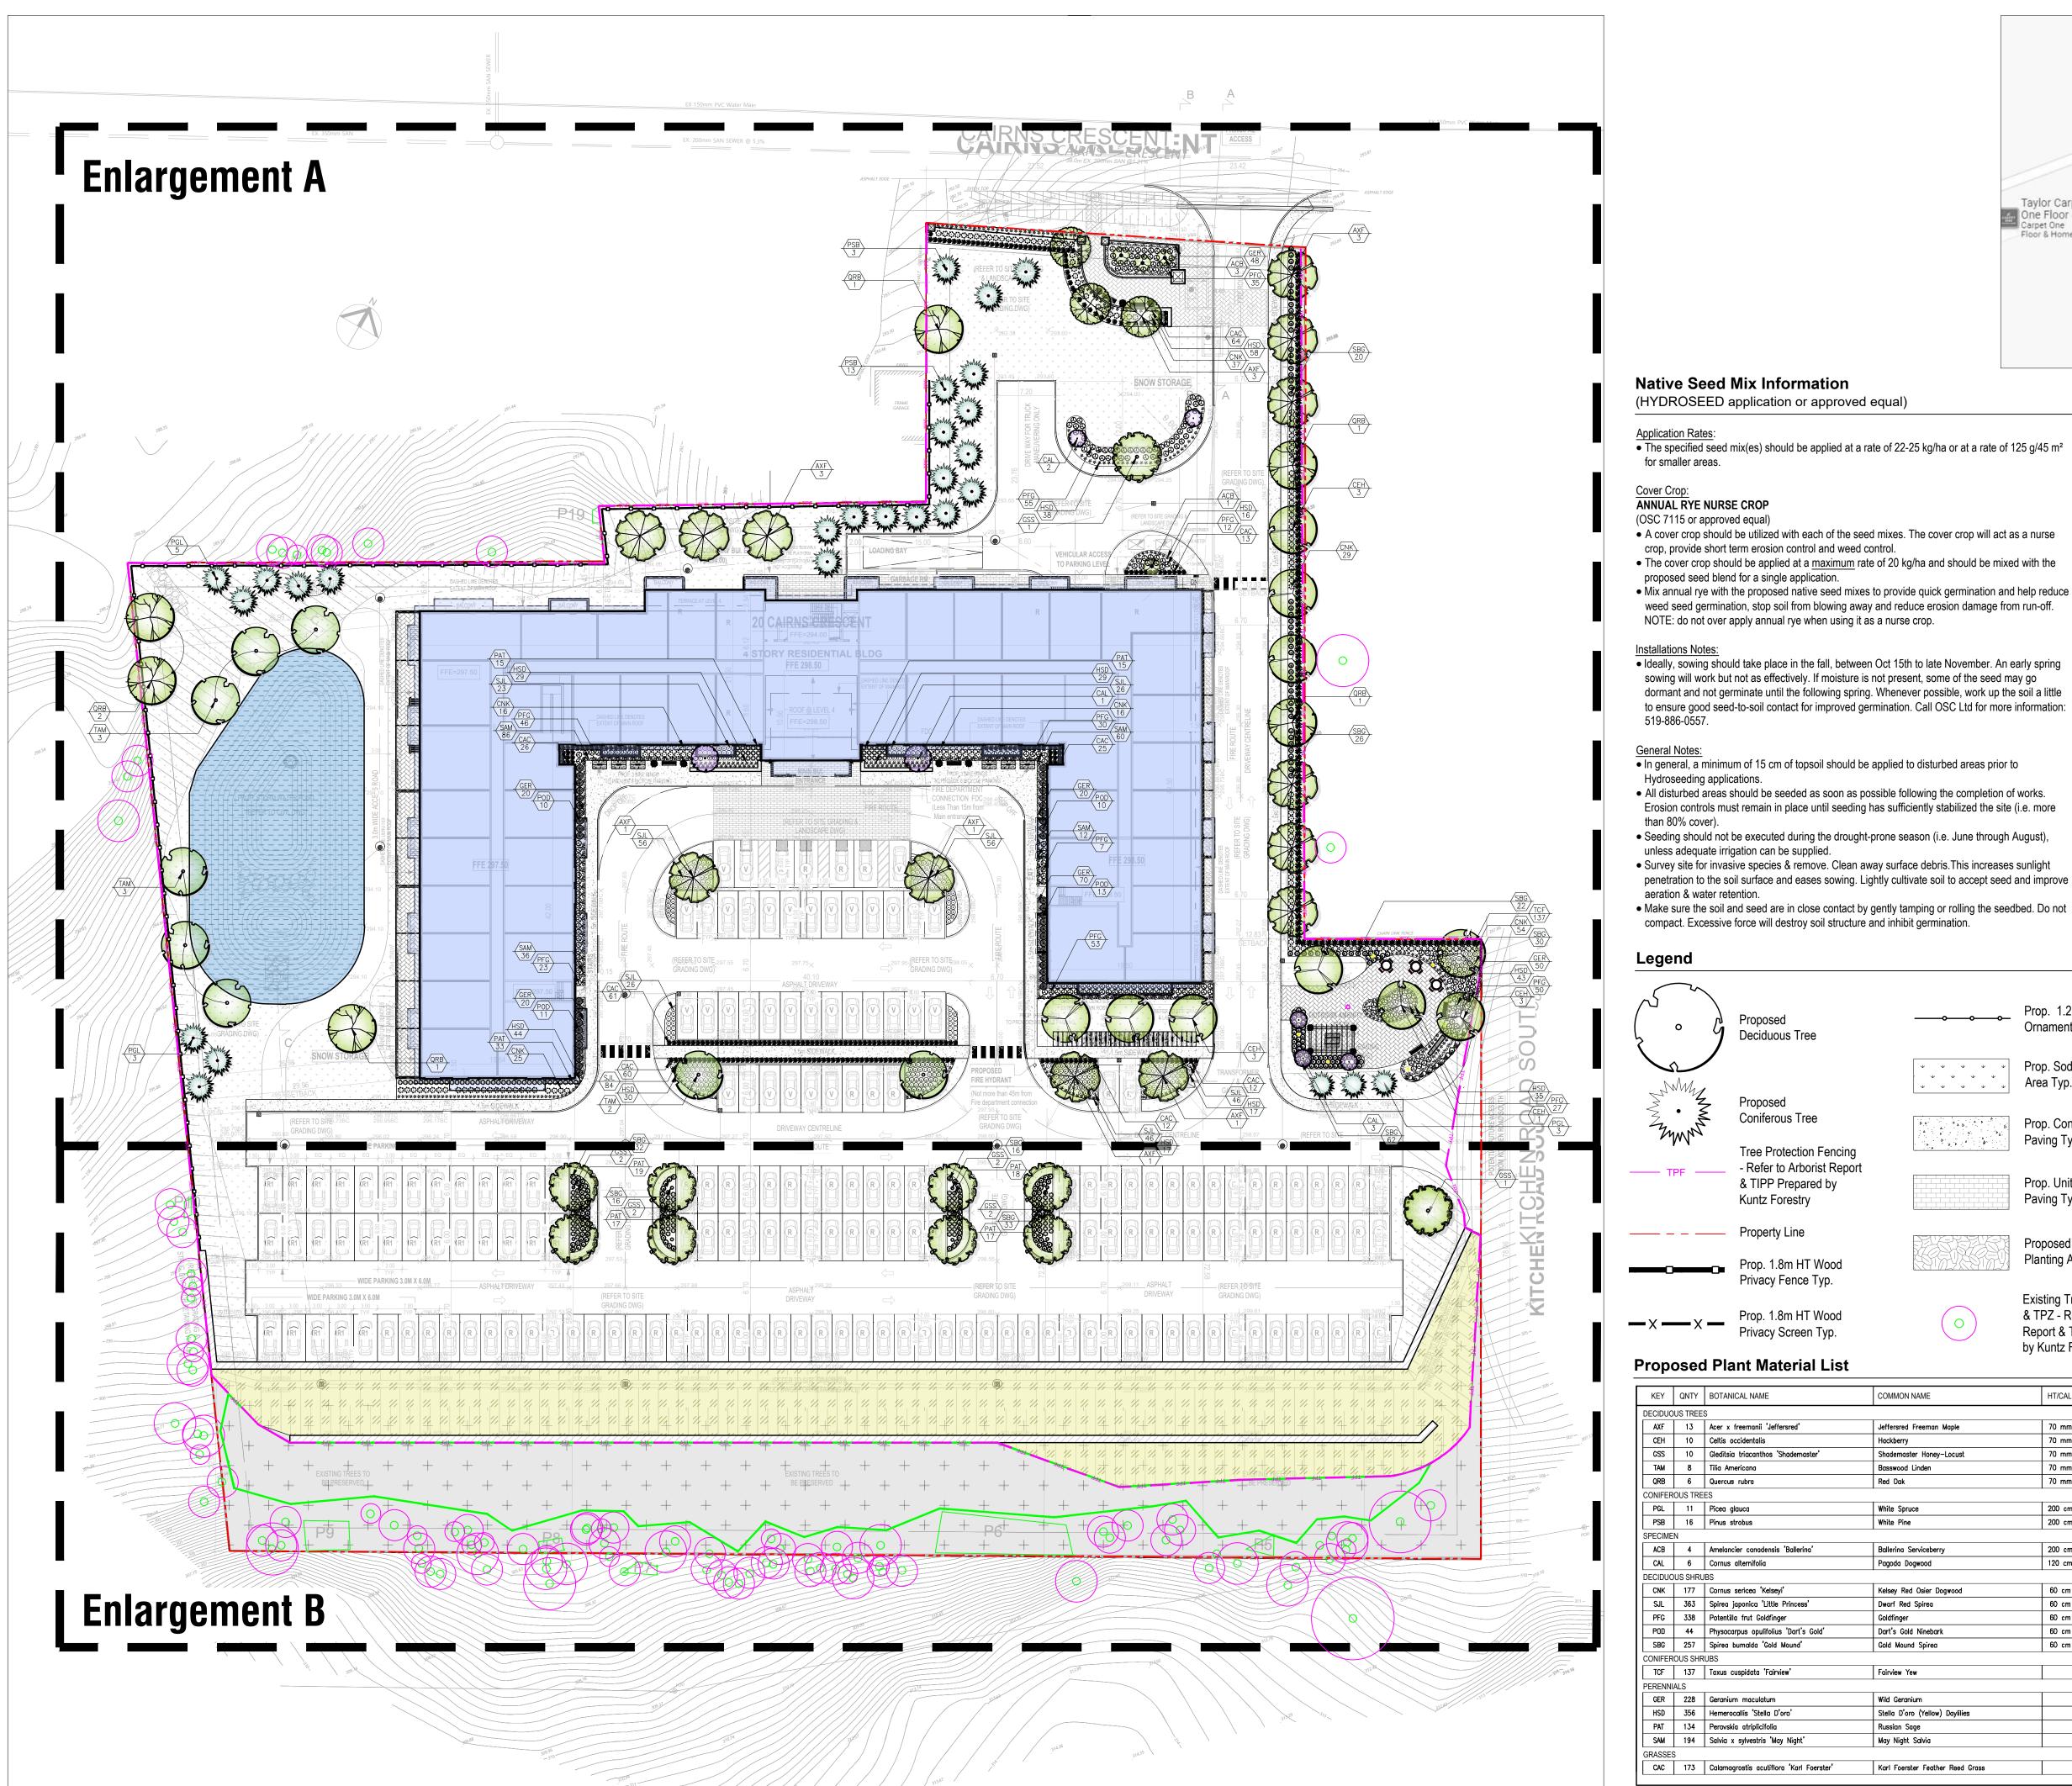



Native Seed Mix Information

(HYDROSEED application or approved equal)

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The specified seed mix(es) should be applied at a rate of 22-25 kg/ha or at a rate of 125 g/45 m² for smaller areas.

ANNUAL RYE NURSE CROP

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• Survey site for invasive species & remove. Clean away surface debris. This increases sunlight penetration to the soil surface and eases sowing. Lightly cultivate soil to accept seed and improve

Wild Bergamot

CVC 2 - Naturalized Wetland Meadow Mix*

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*Note: Developed by OSC (Ontario Seed Company)

Glyceria grandis

CVC 7 - Upland Native Meadow Mix* **S2**

Tall Mannagrass

Aster cordifolius Heart Leaved Aster Canada Anemone Anemone canadensis Canada Goldenrod Solidago canadensis Common Milkweed Asclepias syriaca Oenethera biennis Evening Primrose Grass Leaved Goldenrod Euthamia graminifolia Meadow Sedge Carex granularis New England Aster Aster novae-angliae Riverbank Wild Rye Elymus riparius Virgins Bower Clematis virginiana

*Note: Developed by OSC (Ontario Seed Company)

Monarda fistulosa

Ornamental Fence Typ. Deciduous Tree Prop. Sodd Area Typ.

Coniferous Tree Tree Protection Fencing

- Refer to Arborist Report & TIPP Prepared by Kuntz Forestry

—— — Property Line Prop. 1.8m HT Wood

Privacy Fence Typ.


Prop. Concrete Paving Typ.

Prop. Unit Paving Type 1

Proposed Planting Area

Existing Tree to Remain & TPZ - Refer to Arborist

Report & TIPP Prepared by Kuntz Forestry

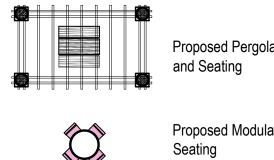

Reference Key

Proposed Plant Material List

KEY	QNTY	BOTANICAL NAME	COMMON NAME	HT/CAL	SPREAD	ROOT	DROUGHT TOLERANT	NATIVE	REMARKS
DECIDUO	US TREES	5	'						
AXF	13	Acer x freemanii 'Jeffersred'	Jeffersred Freeman Maple	70 mm		B.&B.	High	Yes	Full Form
CEH	10	Celtis occidentalis	Hackberry	70 mm		В.&В.	High	Yes	Full Form
GSS	10	Gleditsia triacanthos 'Shademaster'	Shademaster Honey-Locust	70 mm		B.&B.	High	Yes	Full Form
TAM	8	Tilia Americana	Basswood Linden	70 mm		B.&B.	High	Yes	Full Form
QRB	6	Quercus rubra	Red Dak	70 mm		В.&В.	High	Yes	Full Form
ONIFEROUS TREES									
PGL	11	Picea glauca	White Spruce	200 cm		B.&B.	High	Yes	Full Form
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SPECIMEN									
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POD	44	Physocarpus opulifolius 'Dart's Gold'	Dart's Gold Ninebark	60 cm		C.G.	High	Yes	Dwarf
SBG	257	Spirea bumalda 'Gold Mound'	Gold Mound Spirea	60 cm		C.G.	High	Yes	Full Form
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TCF	137	Taxus cuspidata 'Fairview'	Fairview Yew		65 cm	C.G.	High	Yes	Full Form
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HSD	356	Hemerocallis 'Stella D'oro'	Stella D'oro (Yellow) Daylilies			2 Gal.	Yes	No	Full Form
PAT	134	Perovskia atriplicifolia	Russian Sage			2 Gal.	High	Yes	Full Form (PPOY Winner)
SAM	194	Salvia x sylvestris 'May Night'	May Night Salvia			2 Gal.	Yes	No	Full Form
GRASSES	3								
CAC	173	Calamagrostis acutiflora 'Karl Foerster'	Karl Foerster Feather Reed Grass			5 Gal.	Hìgh	Yes	Full Form (PPOY Winner)



170 The Donway W Suite 206. Toronto, Ontario, Canada. M3C 2G3

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Architect:

Client/Owner:





Issued for Coordination 07 Issued for Coordination 06 Issued for Submission 09/09/24 05 Issued for Coordination Issued for Re-Submission 03 Issued for Submission 02 Issued for Coordination 01 Issued for Coordination





Residential Apartment


20 Cairns Crescent, Huntsville,

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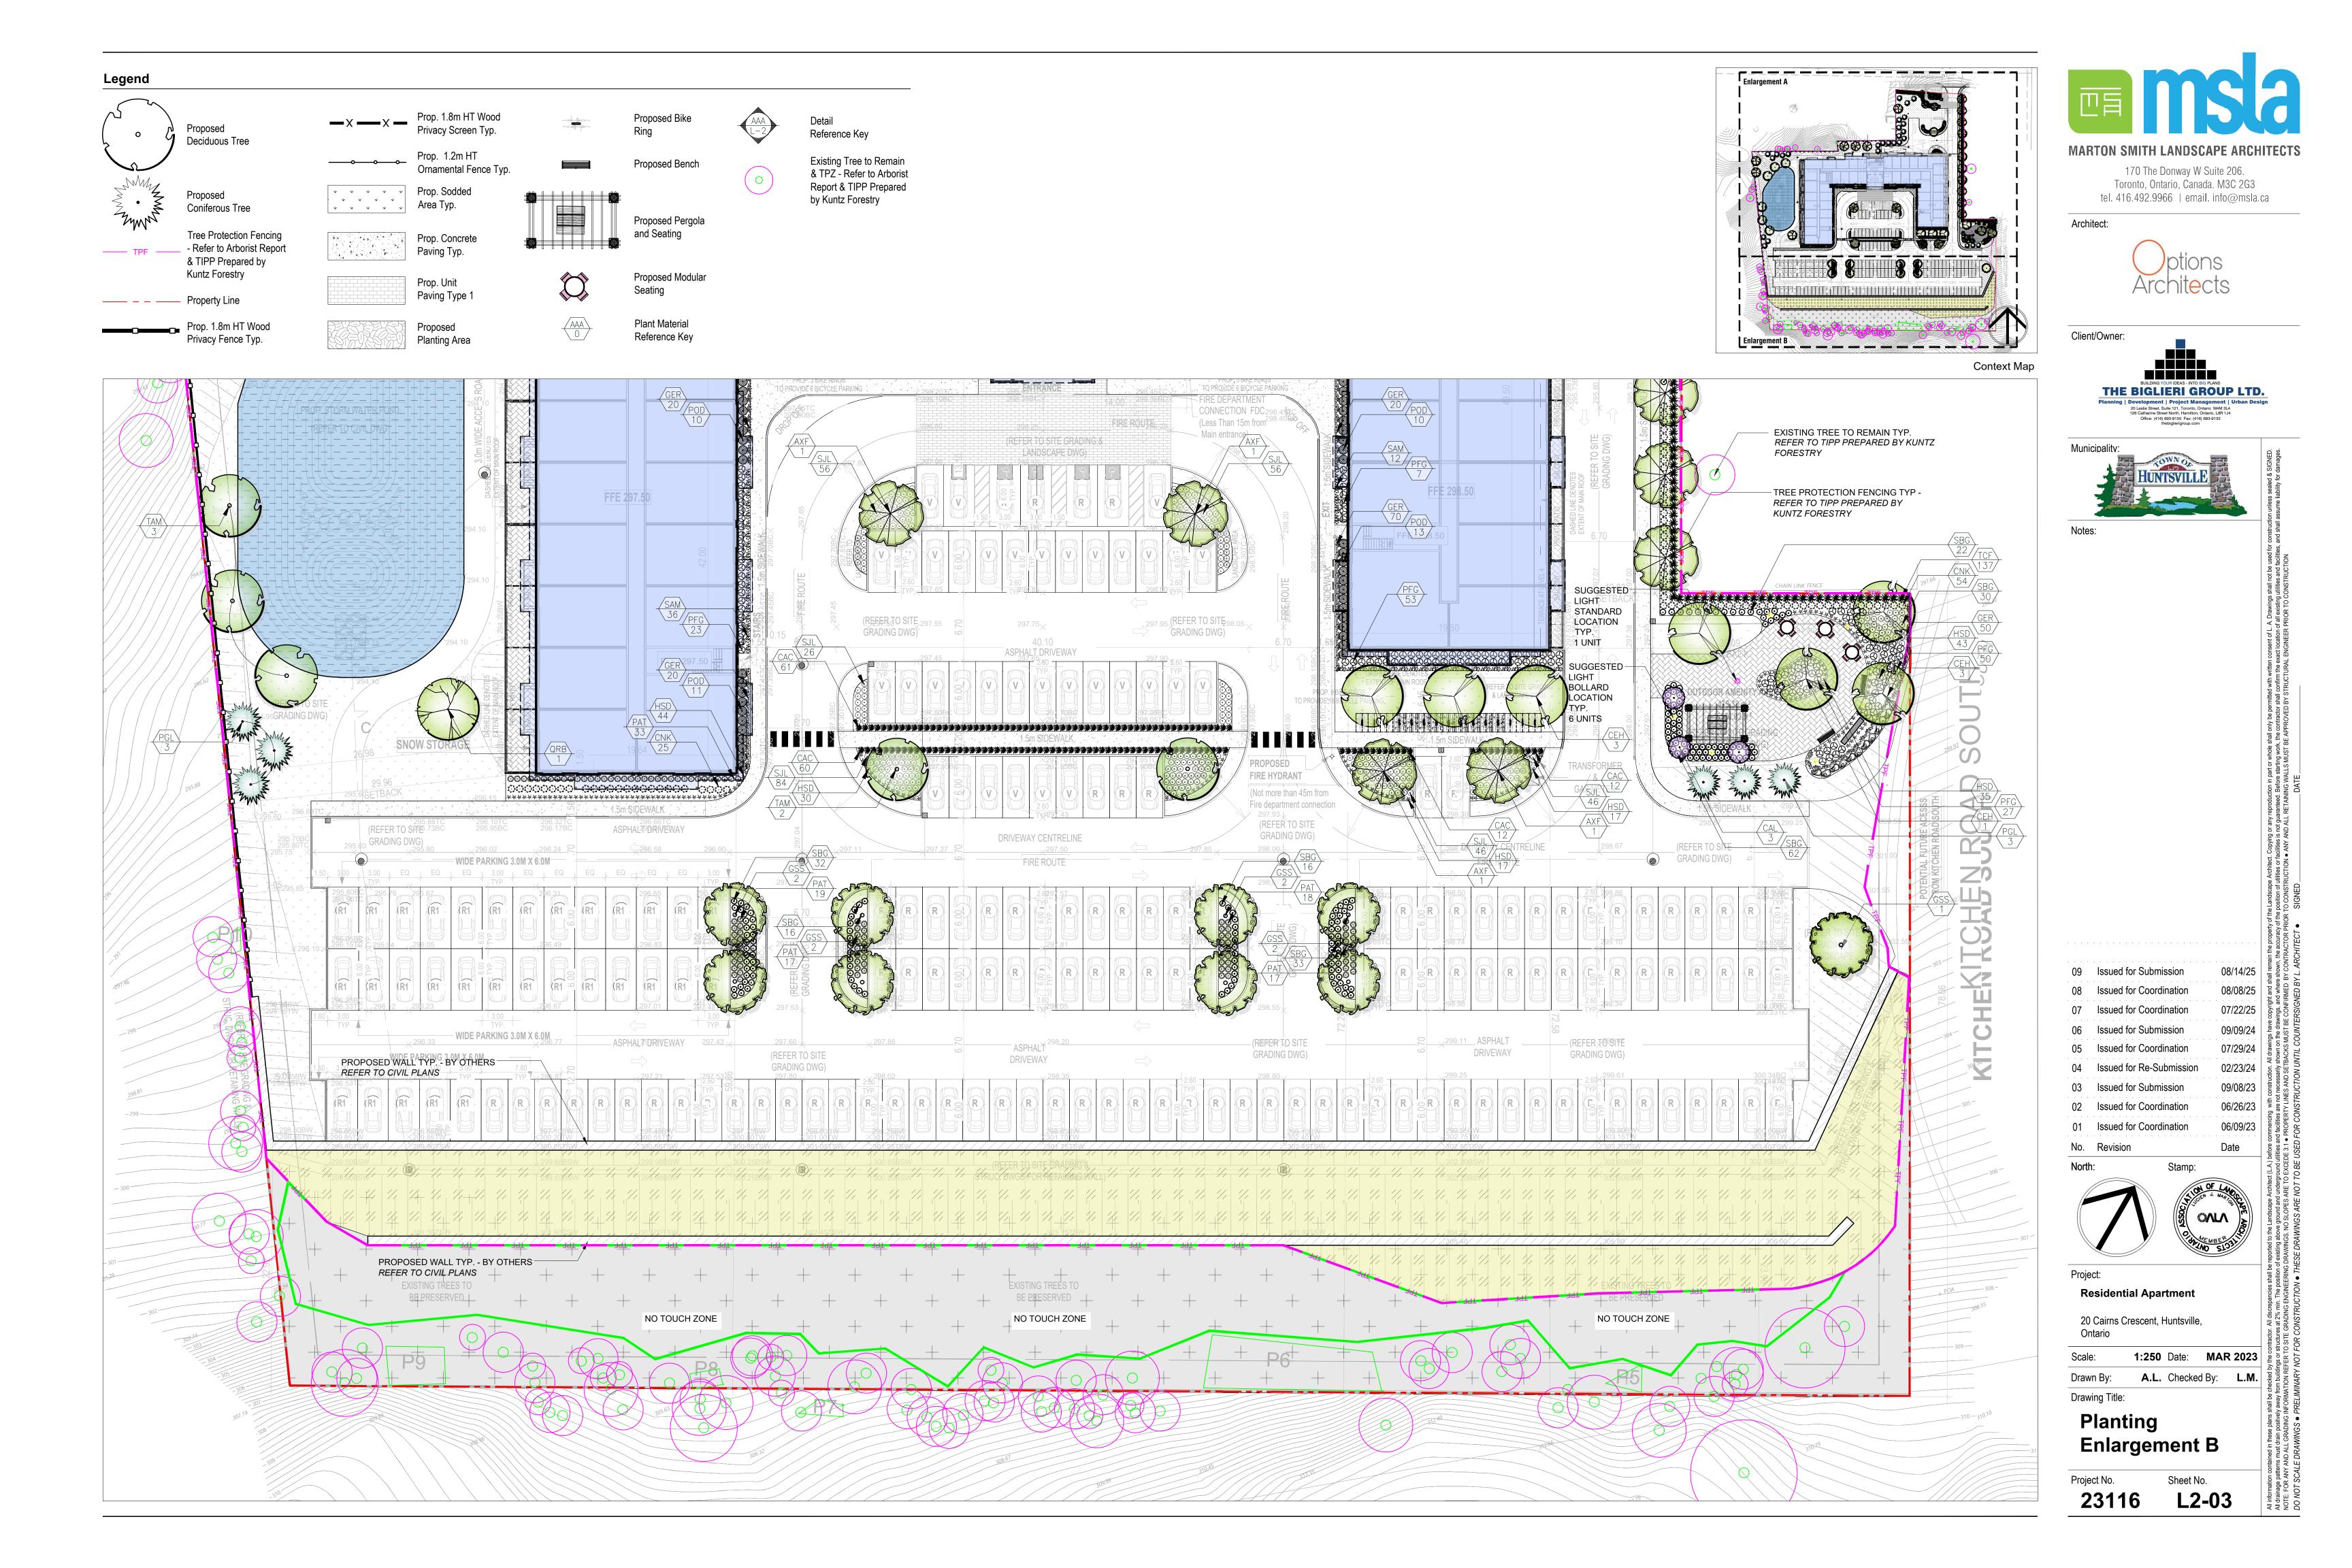
A.L. Checked By: L.M. Drawing Title:

Landscape **Planting Plan**

23116 L2-01



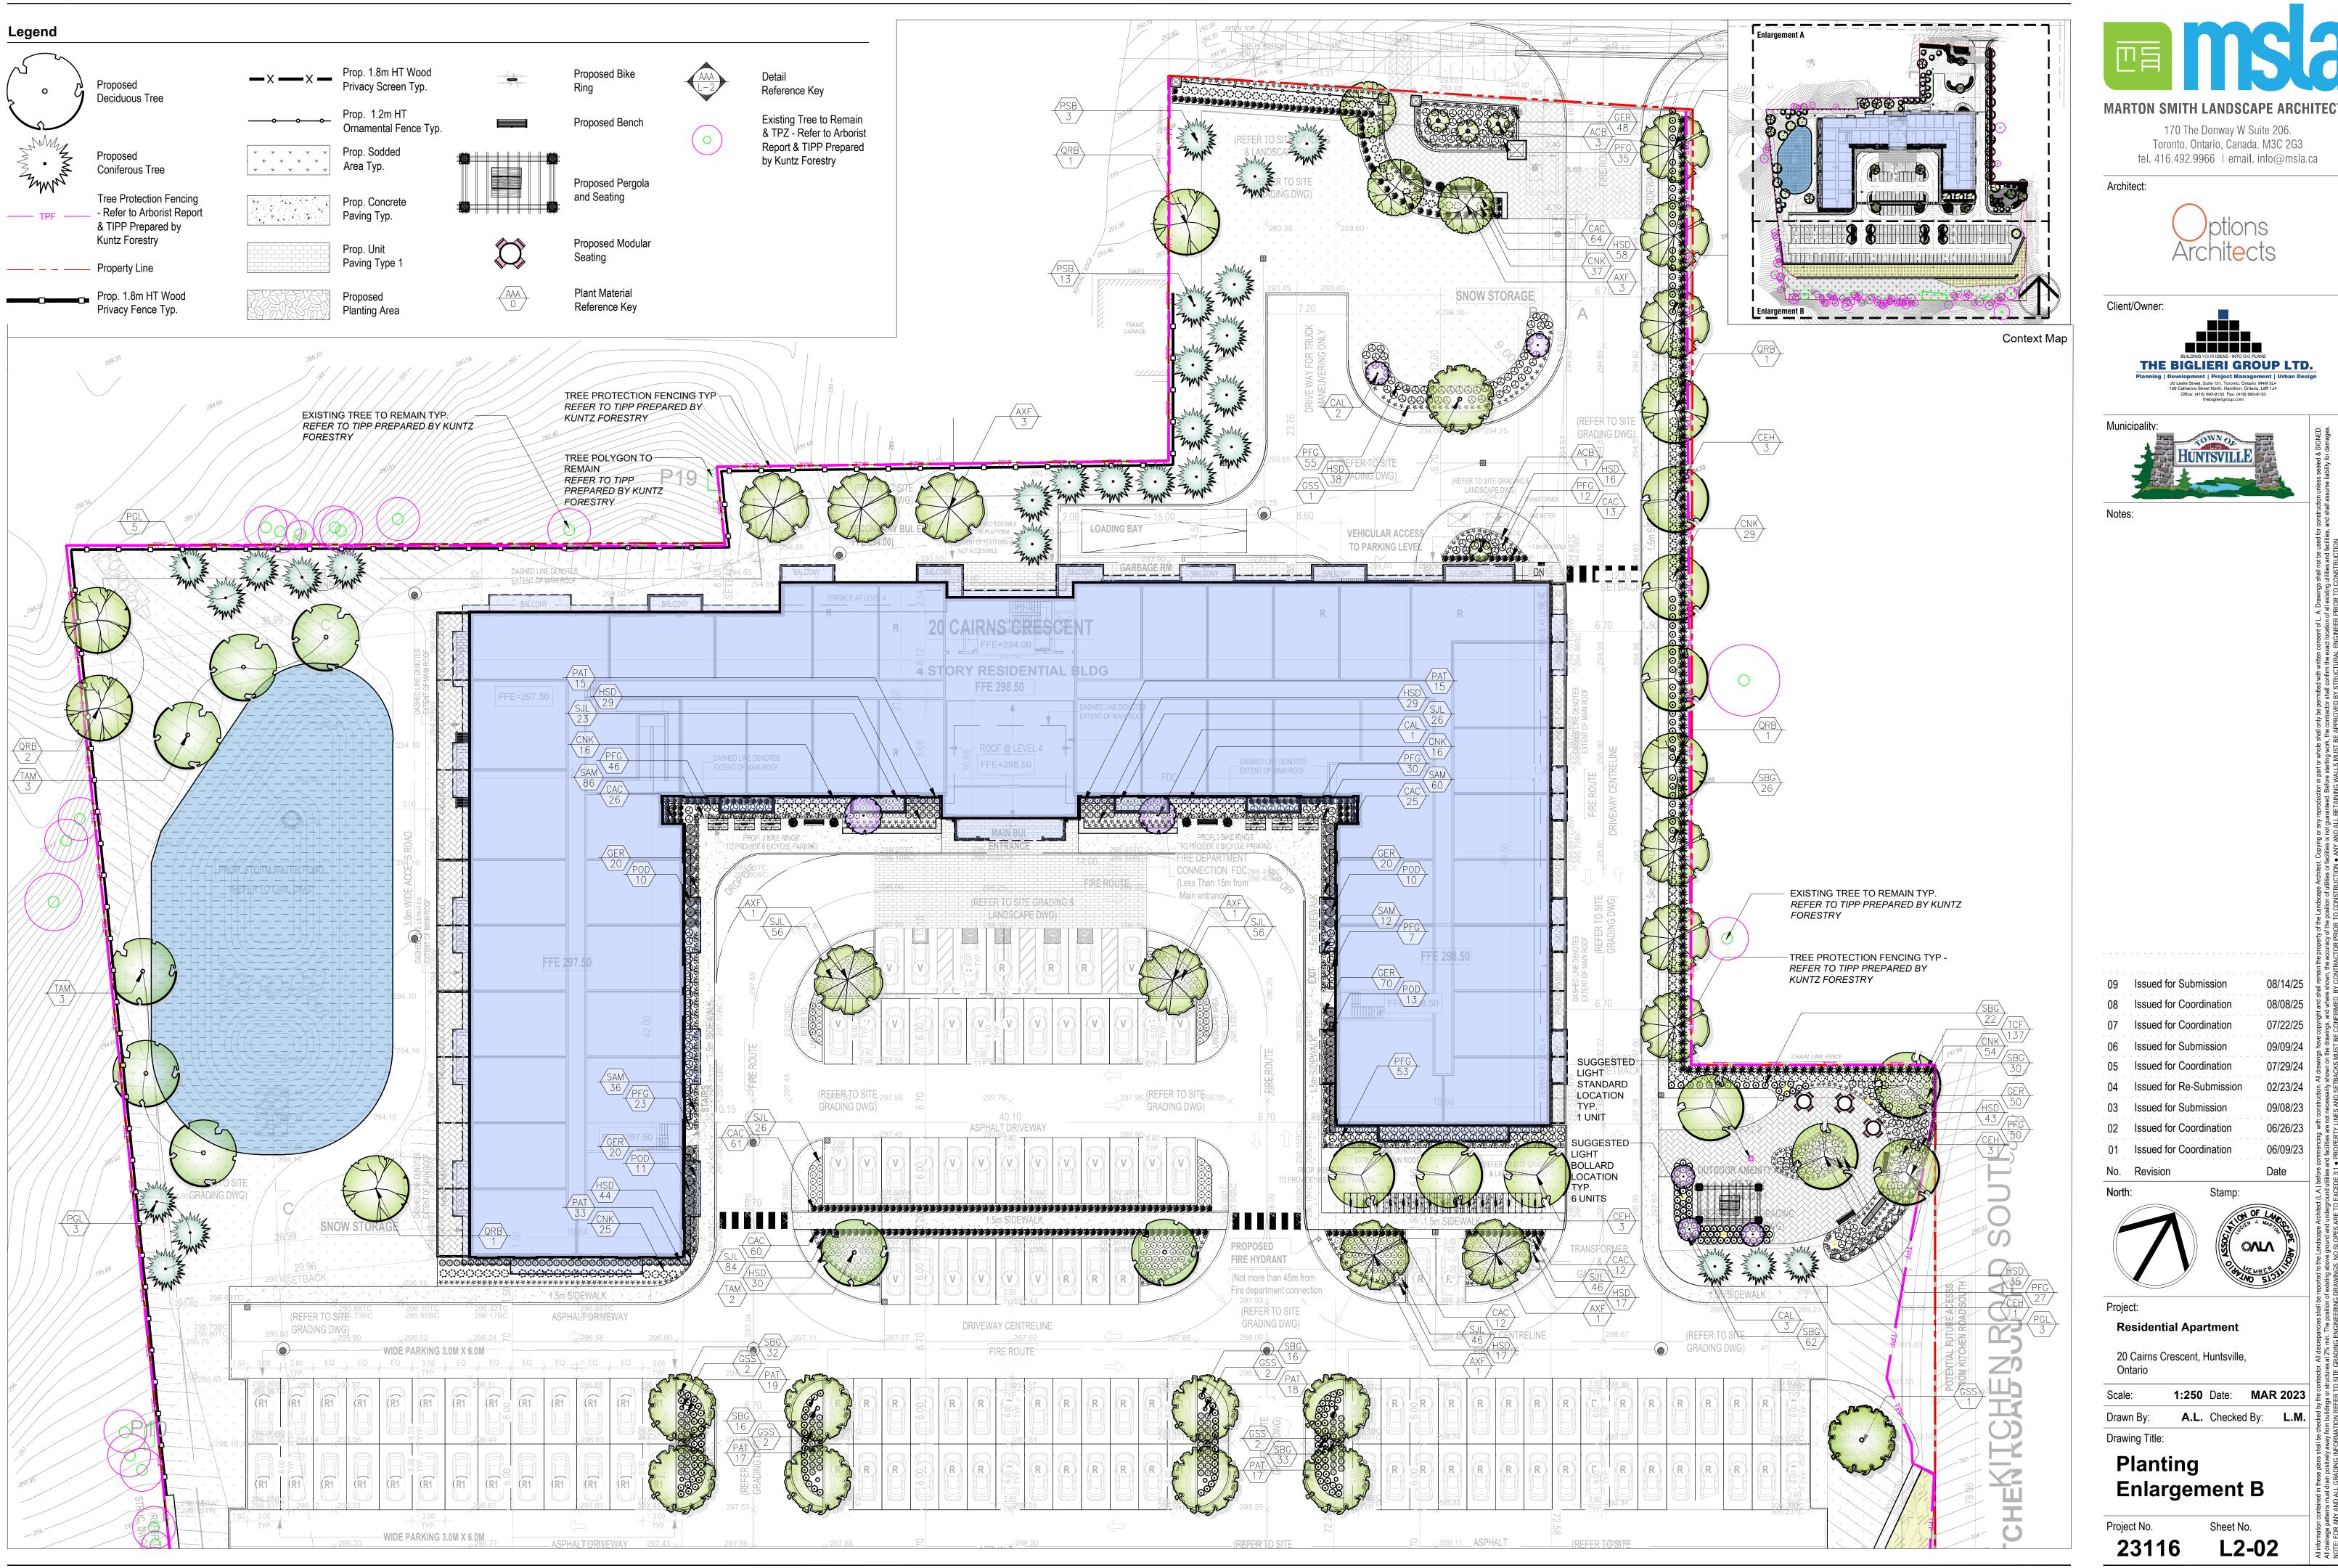



ROUGH GRADE AND FILL AREAS TO ESTABLISH SUBGRADE AS REQUIRED. PROVIDE DRAINAGE PATTERN AS INDICATED ON DRAWINGS. ROUND SMOOTHLY ALL TOPS AND TOES OF SLOPES. COMPACT ALL AREAS TO 95% STANDARD PROCTOR DENSITY UNLESS SPECIFIED OTHERWISE. EXISTING TREES TO REMAIN ON SITE ARE TO BE PROTECTED AS DETAILED.

FINE GRADE ALL AREAS TO FINISHED GRADES AS SHOWN ON LAYOUT OR GRADING PLAN OR ARCHITECT'S SITE PLAN. PROVIDE UNIFORM SLOPES AWAY FROM THE BUILDING, UNLESS SPECIFIED OTHERWISE. SLOPES MAY NOT EXCEED 33 1/3% (3:1).

SCARIFY THE SUBSOIL PRIOR TO THE SPREADING THE TOPSOIL. REMOVE ALL DEBRIS AND LEAVE A FINE-TEXTURED EVEN SURFACE. ALL TOPSOIL TO BE IMPORTED UNLESS PREVIOUSLY APPROVED BY LANDSCAPE ARCHITECT. OBTAIN APPROVAL FOR THE QUALITY OF ANY IMPORTED TOPSOIL BEFORE DELIVERY TO THE SITE. TOPSOIL IS TO BE COMPACTED TO CREATE A FIRM AND EVEN SURFACE.

USE NO. 1 GRADE TURFGRASS NURSERY SOD WHICH CONFORMS WITH THE SPECIFICATIONS OF THE NURSERY SOD GROWERS ASSOCIATION OF ONTARIO. ALL LAWN AREAS SHALL RECEIVE A MINIMUM OF 100MM (4") OF COMPACTED TOPSOIL, AND SHALL BE SODDED WITH #1 KENTUCKY BLUEGRASS - FESCUE. NO SOD SLOPES ARE TO EXCEED 3:1. SLOPE IN EXCESS OF 4:1 TO BE PEGGED.

MINERAL FERTILIZER

APPLY THE FOLLOWING MINERAL FERTILIZER UNLESS SOILS TESTS SHOW OTHER REQUIREMENTS:

1. SODDED AREAS - 11% NITROGEN, 8% PHOSPHORUS AND 4% POTASH (11-8-4) AT THE RATE OF 4.5 KG OVER M2 (10 LBS OVER 1000 SQ.

2. PLANTING BEDS - 7% NITROGEN, 7% PHOSPHORUS AND 7% POTASH (7-7-7) AT THE RATE OF 40 GRAMS (4 OZ.) FOR EVERY BUSHEL OF

PREPARATION OF PLANTING BEDS


ALL PLANT BEDS TO BE CONTINUOUS. EXCAVATE ALL PLANTING BEDS TO THE DEPTH AS INDICATED ON THE DRAWINGS AND DETAILS, MIN 450mm(18"). BACKFILL ALL PLANTING BEDS WITH A SOIL MIXTURE CONSISTING OF SIX (6) PARTS OF SAND LOAM, ONE (1) PART OF FINELY PULVERIZED PEAT MOSS, TWO (2) PARTS OF WELL-ROTTED MANURE AND THE MINERAL FERTILIZER AS SPECIFIED ABOVE. ALSO ADD .58 KILOS BONEMEAL/CUBIC METER OF PLANTING SOIL (1 LB./CUBIC YARD). PREPARE THE PLANTING BEDS FOR PLANTING BEFORE THE DELIVERY OF THE PLANT MATERIAL TO THE JOB SITE.

NOTE: IF THE EXISTING SOIL CONDITIONS ARE CLAY OR WET IN NATURE, CONTACT THE LANDSCAPE ARCHITECT FOR INSTRUCTIONS OF A SUITABLE SOIL MIXTURE. FAILURE TO DO THIS MAY RESULT IN DELAY OF APPROVAL AND ACCEPTANCE. PLANT MATERIALS

ALL PLANT MATERIAL SHALL CONFORM TO THE STANDARDS OF THE CANADIAN NURSERY TRADES ASSOCIATION FOR SIZE AND

ALL SHRUB AND TREE MATERIAL SHALL BE CONTAINER GROWN, POTTED, S/B OR B/B, UNLESS OTHERWISE NOTED. BARE ROOT PLANTING SHALL BE ACCEPTABLE FOR CERTAIN SPECIES DURING EARLY SPRING OR LATE FALL PLANTING SEASON. CONTRACTOR SHALL MAKE REQUESTS FOR ROOT CONDITION SUBSTITUTION IN WRITING TO THE LANDSCAPE ARCHITECT PRIOR TO COMMENCEMENT OF PLANTING OPERATIONS. ALL PLANT MATERIAL TO BE CLAY GROWN STOCK UNLESS OTHERWISE NOTED.

LANDSCAPE SPECIFICATIONS

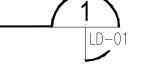

PLANT MATERIAL INSTALLATION

ALL TREES, SHRUBS AND GROUNDCOVERS SHALL BE PLANTED AS DETAILED & AS SHOWN ON THE PLANTING PLAN. ALL BEDS TO RECEIVE A COVER OF CLEAN MULCH TO A DEPTH OF 75mm(3"). FOR GUYING AND STAKING TREES, REFER TO PLANTING DETAILS. WRAP ALL DECIDUOUS TREES UNDER EXPERIENCED SUPERVISION ONLY TO THE SPECIFICATIONS OF THE ONTARIO LANDSCAPE

PLANT MATERIAL SIZES AND CONDITIONS ARE TO BE AS INDICATED ON THE LANDSCAPE DRAWING.

THE INDIVIDUAL PLANT GROUPING TOTAL AS ILLUSTRATED ON THE PLANTING PLAN SUPERSEDES THE ESTIMATED QUANTITY ON THE MASTER PLANT LIST. CONTRACTOR MUST REPORT ANY DISCREPANCIES TO THE LANDSCAPE ARCHITECT IN WRITING BEFORE COMMENCING ANY WORK. CONTRACTOR WILL ASSUME FULL RESPONSIBILITY IF LANDSCAPE ARCHITECT IS NOT NOTIFIED. OF

* MULCH - SHREDDED PINE MULCH BY "GRO BARK" OR APPROVED EQUAL. LANDSCAPE ARCHITECT TO APPROVE MULCH BEFORE INSTALLATION.

GENERAL MAINTENANCE

PROPER MAINTENANCE PROCEDURES ARE TO BE FULLY ADMINISTERED FOR ALL NEWLY CONSTRUCTED LANDSCAPE WORK, IN ACCORDANCE WITH LANDSCAPE ONTARIO SPECIFICATIONS (SECTION 1E - MAINTENANCE WORK). THIS SHALL APPLY ONLY DURING THE CONSTRUCTION PERIOD, UNLESS OTHERWISE SPECIFIED. CONTRACTOR IS RESPONSIBLE FOR MAINTENANCE OF SOD AND PLANTING UNTIL FINAL ACCEPTANCE BY LANDSCAPE ARCHITECT.

RODENT PROTECTION

THE CONTRACTOR SHALL BE RESPONSIBLE FOR THE PROTECTION OF ALL TREES AND SHRUBS FOR WINTER PROTECTION AND FROM RODENT INJURY FOR THE DURATION OF GUARANTY PERIOD. PROTECTIVE GUARDS SHALL BE EMPLOYED AROUND ALL DECIDUOUS TREES, GUARDS TO BE 150MM DIA, PVC PIPE OR AS MUNICIPAL GUIDELINES. GUARDS SHALL BE INSTALLED PRIOR TO THE

ALL SHRUBS AND CONIFEROUS TREES SHALL HAVE AN APPLICATION OF "SKOOT" OR APPROVED EQUIVALENT RODENT FORMULA, TO BE APPLIED AT THE END OF OCTOBER FOLLOW MANUFACTURER'S DIRECTIONS FOR APPLICATION

APPLICATION OF THE MULCH AND SHOULD BE PLACED A MINIMUM OF 50MM (2") OUT FROM THE TREE TRUNK ON ALL SIDES.


USE ABOVE SPECIFICATIONS IN CONJUNCTION WITH THE GENERAL LANDSCAPE SPECIFICATIONS OF THE ONTARIO LANDSCAPE CONTRACTORS ASSOCIATION, THE NURSERY SOD GROWERS ASSOCIATION OF ONTARIO AND WITH THE GUIDE SPECIFICATIONS FOR NURSERY STOCK OF THE CANADIAN NURSERY TRADES ASSOCIATION. USE ONLY PLANT MATERIAL TRUE TO NAME, SIZE AND GRADE AS SPECIFIED ON PLANTING PLAN: PROVIDE SUFFICIENT LABELS OR MARKINGS TO INDICATE CLEARLY THE VARIETY. SIZE AND GRADE OF EACH SPECIMEN OR BUNDLE

OBTAIN APPROVAL FOR SUBSTITUTIONS AS TO VARIETY, SIZE OR GRADE FROM THE LANDSCAPE ARCHITECT. USE ONLY NURSERY STOCK GROWN UNDER PROPER HORTICULTURAL PRACTICES, VIABLE, FREE FROM PEST AND DISEASE AND UNDAMAGED. CHECK LOCATIONS AND OBTAIN STAKEOUTS OF ALL UTILITY LINES BEFORE EXCAVATION. OBTAIN ALL NECESSARY PERMITS BEFORE COMMENCEMENT OF CONSTRUCTION REPORT IN WRITING ANY DISCREPANCIES IN THE DRAWINGS. SPECIFICATIONS AND CONTRACT DOCUMENTS TO THE LANDSCAPE ARCHITECT BEFORE THE END OF THE BIDDING PROCESS AND COMMENCEMENT OF CONSTRUCTION. THESE SPECIFICATIONS MAY BE SUPERCEDED BY ADDITIONAL SPECIFICATIONS SET OUT IN THE TENDER DOCUMENTS. CONTRACTOR TO REVIEW ALL DOCUMENTS

PROVIDE ONE FULL YEAR GUARANTEE ON ALL LANDSCAPE WORK FROM DATE OF FINAL ACCEPTANCE BY LANDSCAPE ARCHITECT. GUARANTEE PERIOD MAY BE EXTENDED TO TWO FULL YEARS DEPENDING ON MUNICIPAL STANDARDS. CONTRACTOR TO VERIFY WITH OWNER AND LANDSCAPE ARCHITECT.

PLANT MATERIAL INSTALLATION

SCALE: N.T.S. DATE:

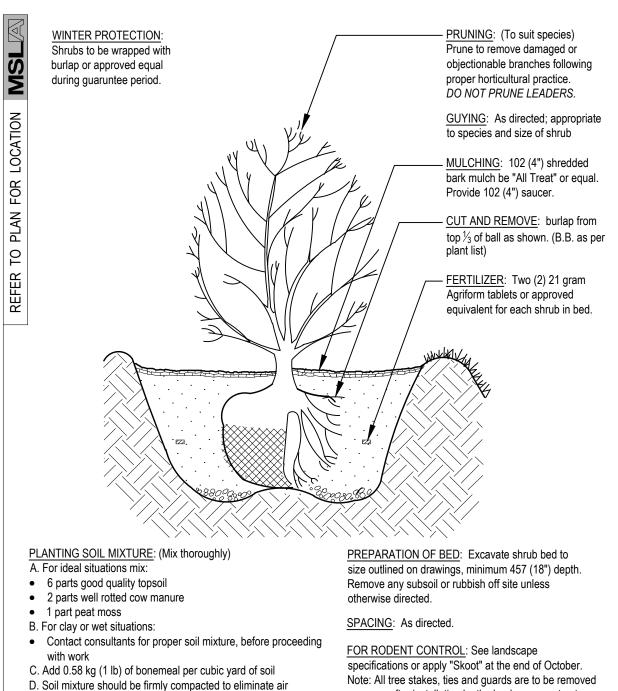



Note: All tree stakes, ties and guards are to be removed one year after installation by the landscape contractor.

STANDARD SHRUB PLANTING DETAIL

SCALE: N.T.S. DATE:


pockets and prevent settlement.

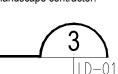

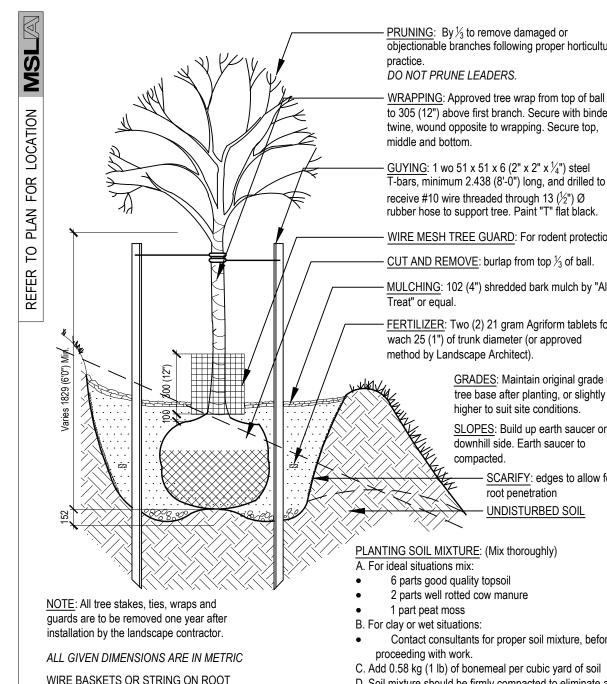


STANDARD DECIDUOUS TREE DETAIL

SCALE: N.T.S. DATE:

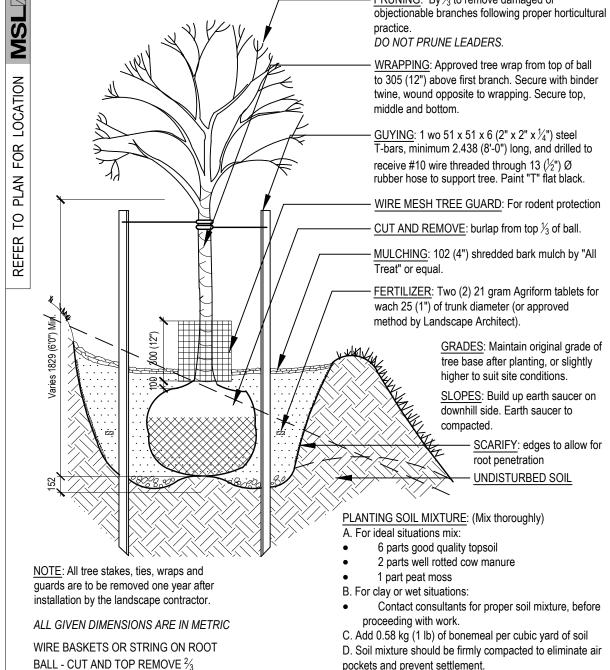





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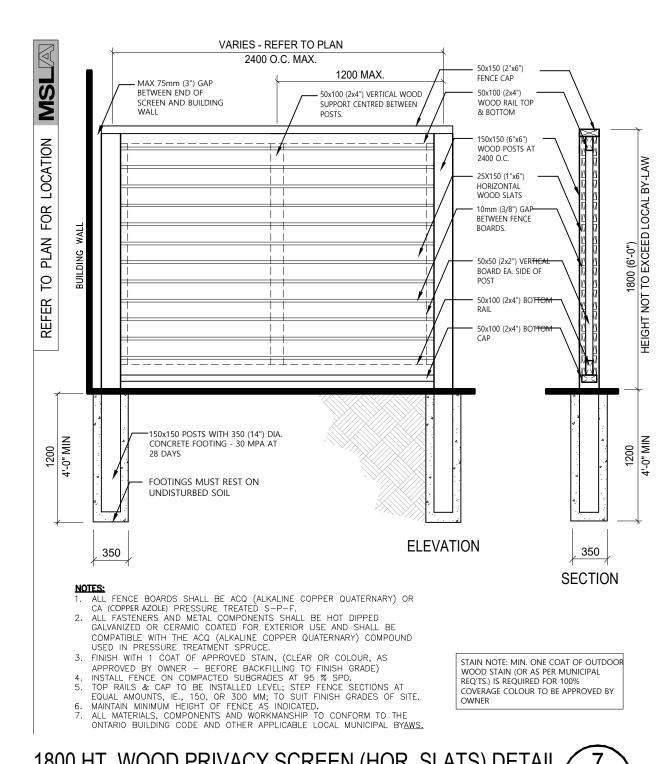


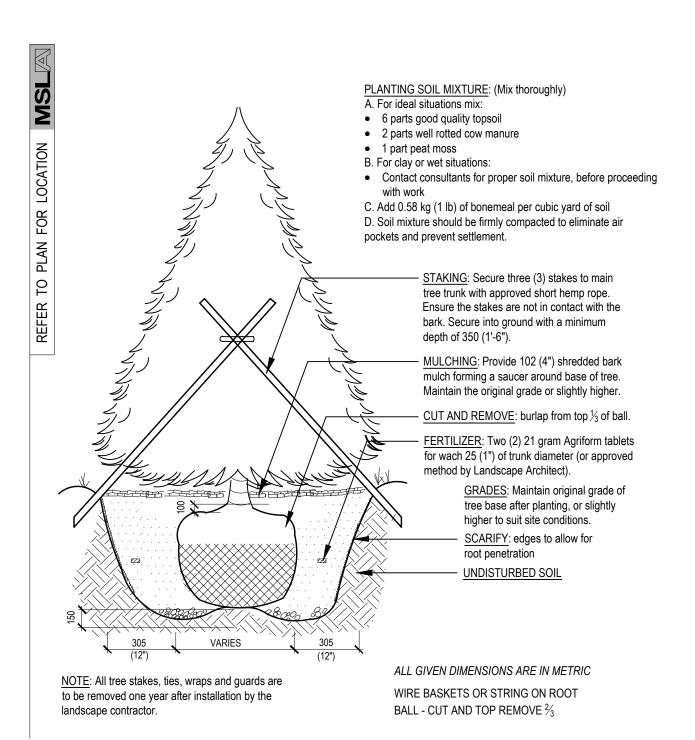

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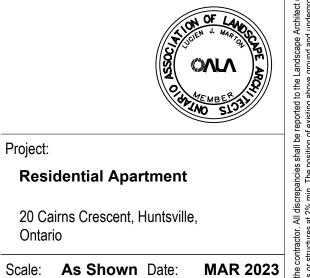




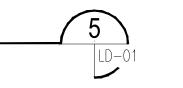

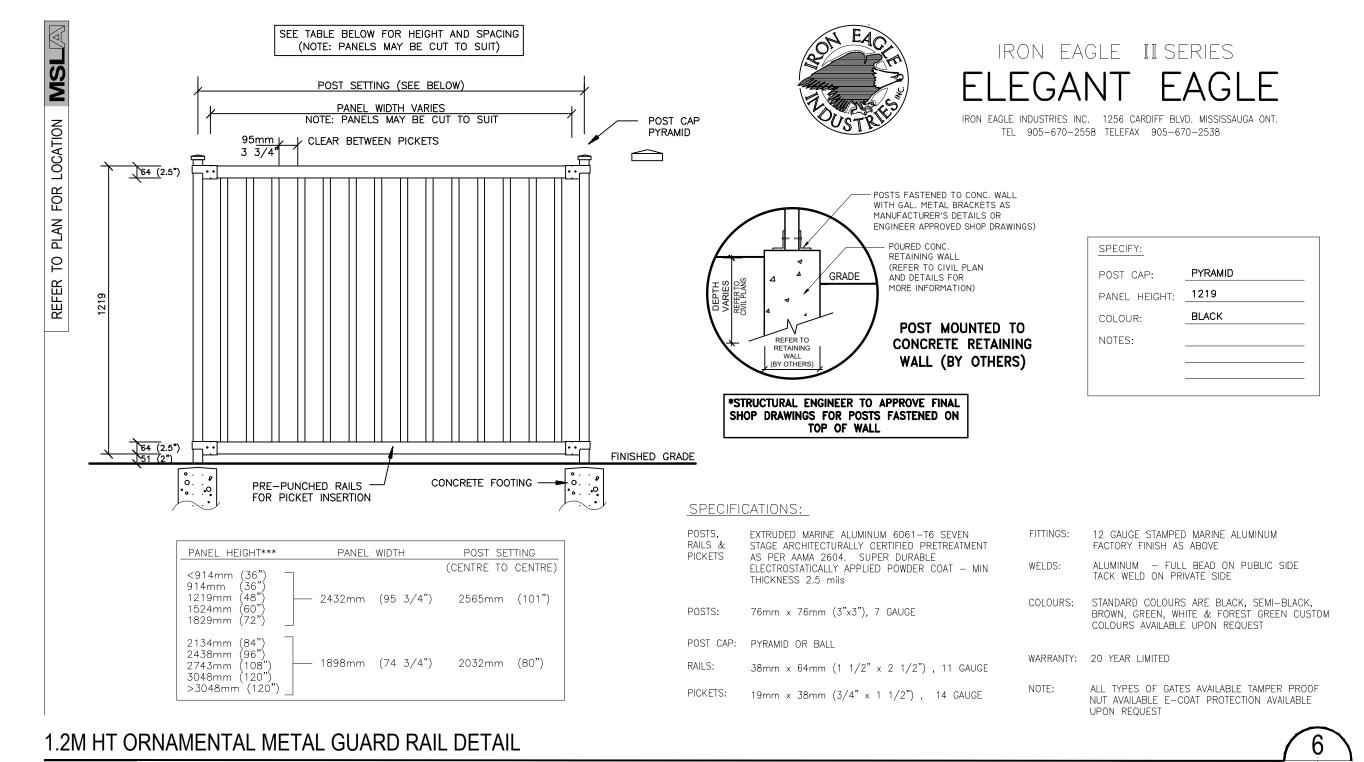

SCALE: N.T.S. 3/8" (10mm) GAP BETWEEN BOARDS



A.L. Checked By: **L.M.**

08/14/25

08/08/25

07/22/25

09/09/24

07/29/24

02/23/24

09/08/23

06/26/23

06/09/23

Date

MARTON SMITH LANDSCAPE ARCHITECTS

170 The Donway W Suite 206.

Toronto, Ontario, Canada, M3C 2G3

tel. 416.492.9966 | email. info@msla.ca

THE BIGLIERI GROUP LTD.

Architect:

Client/Owner:

Landscape **Details**

09 Issued for Submission

08 Issued for Coordination

07 Issued for Coordination

06 Issued for Submission

Issued for Coordination

04 Issued for Re-Submission

03 Issued for Submission

02 Issued for Coordination

No. Revision

Project:


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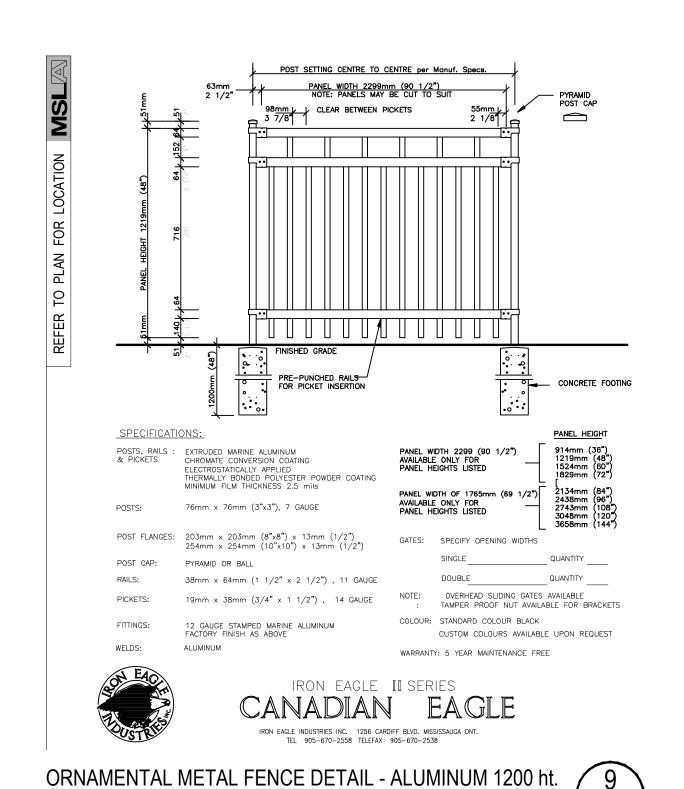
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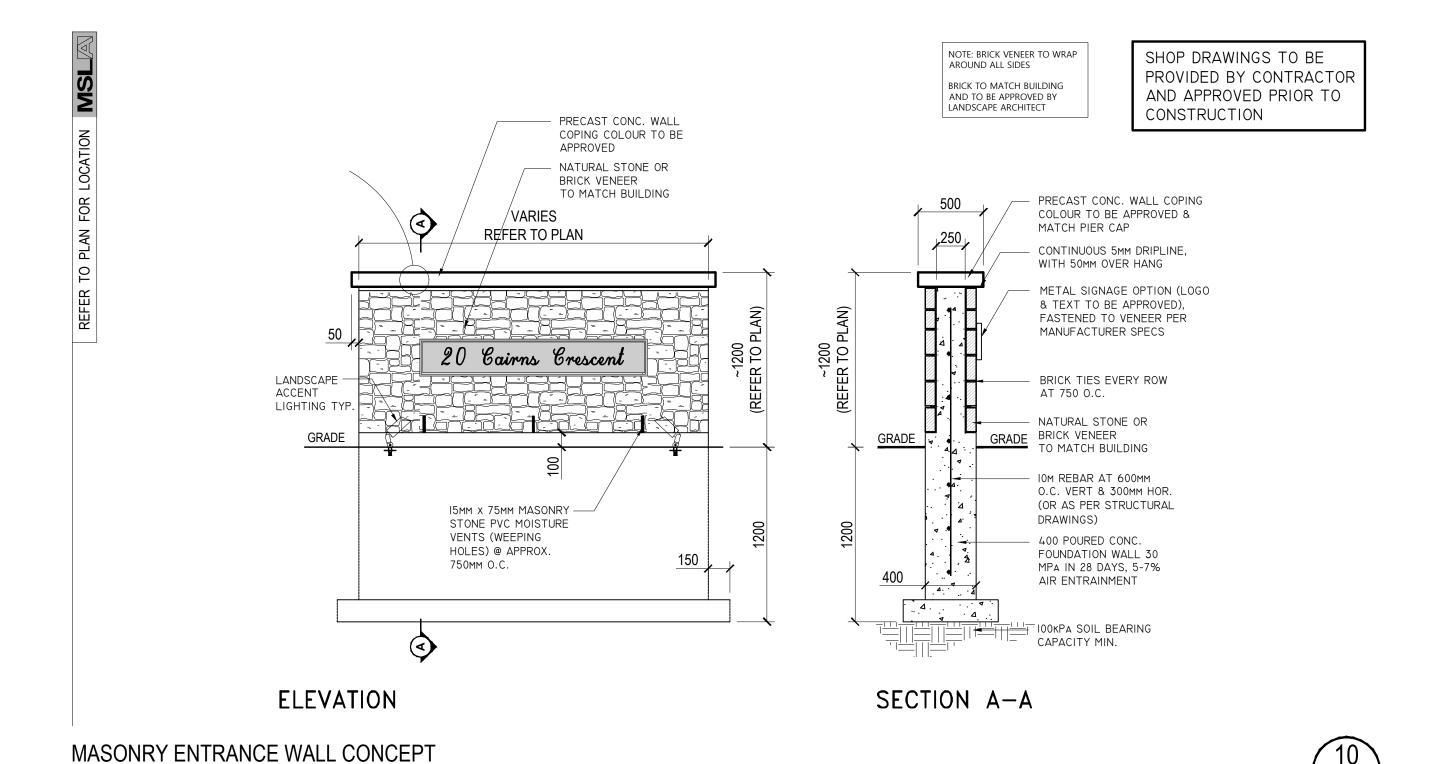
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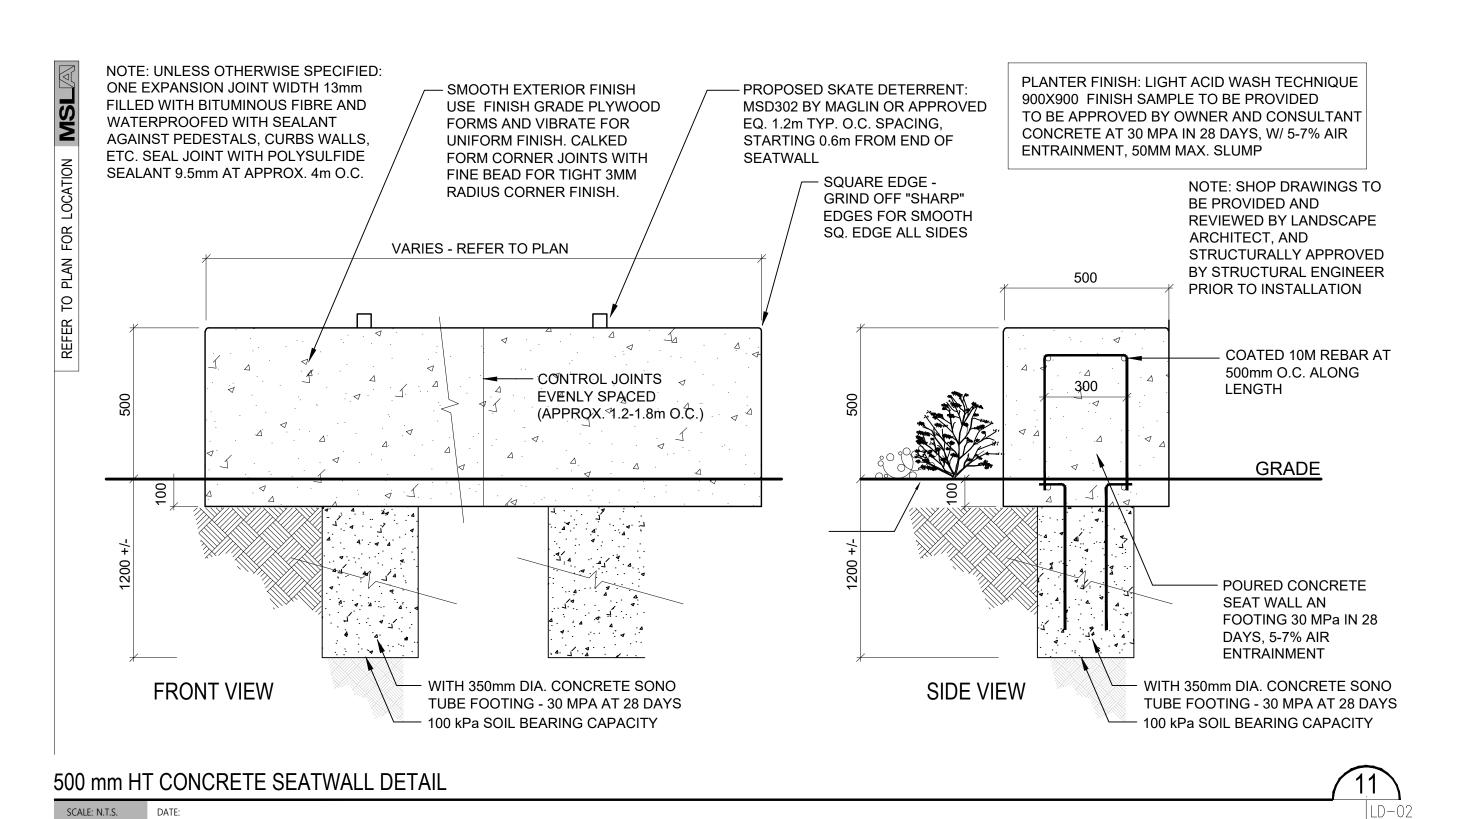
Issued for Coordination

Project No. Sheet No.









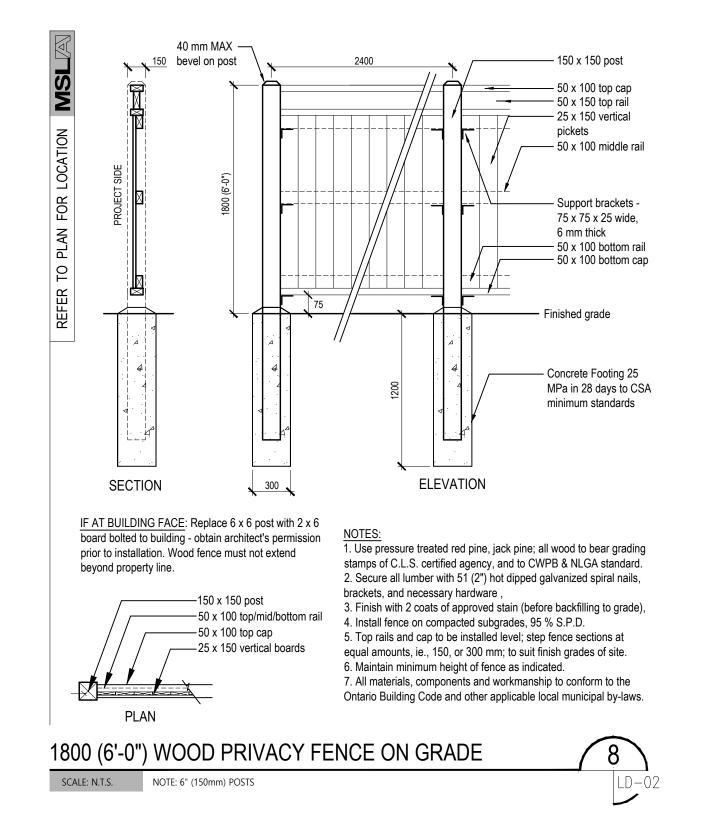


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SCALE: N.T.S. DATE:

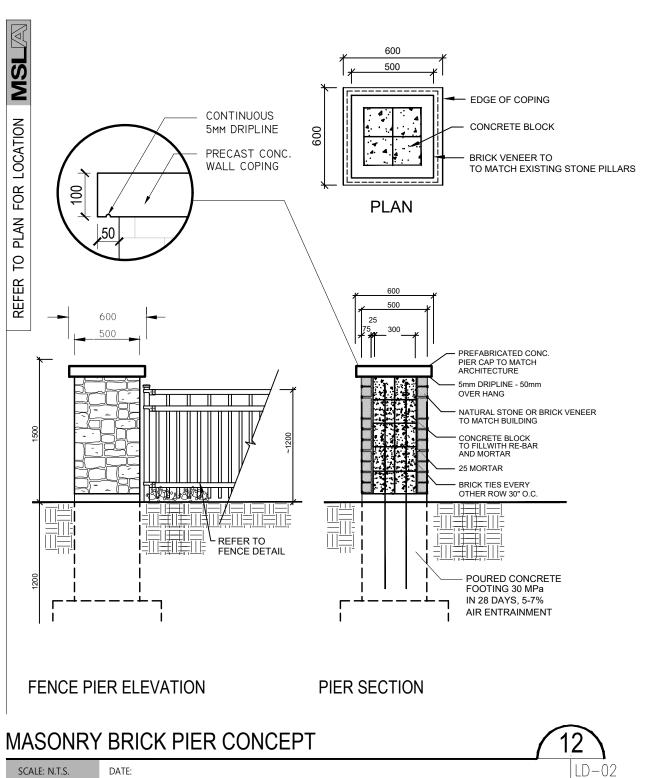



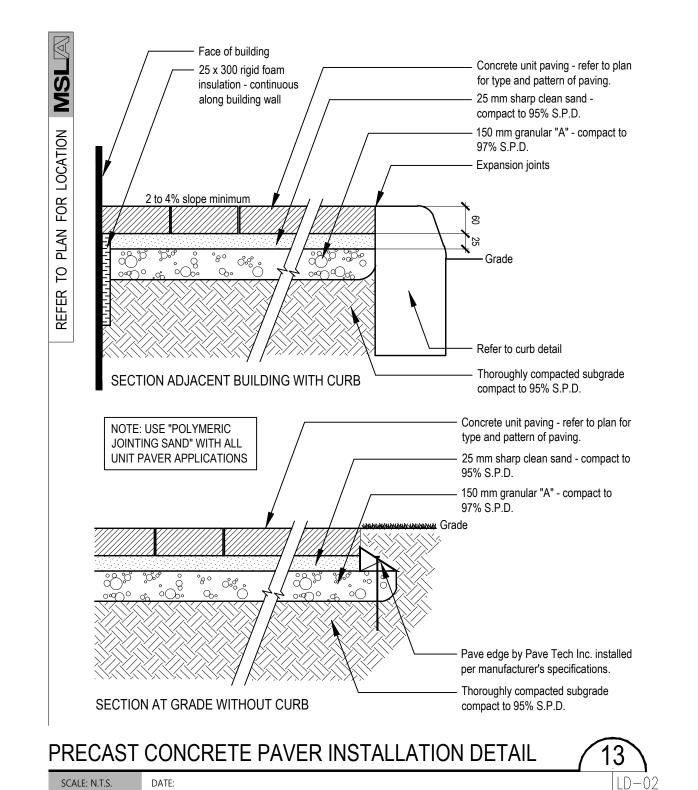

20 Cairns Crescent, Huntsville,

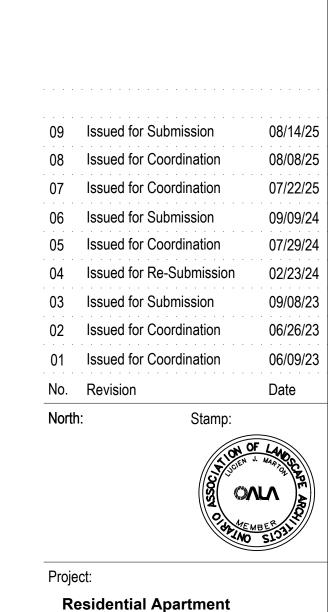Landscape

Drawn By:

Drawing Title:

Project No.


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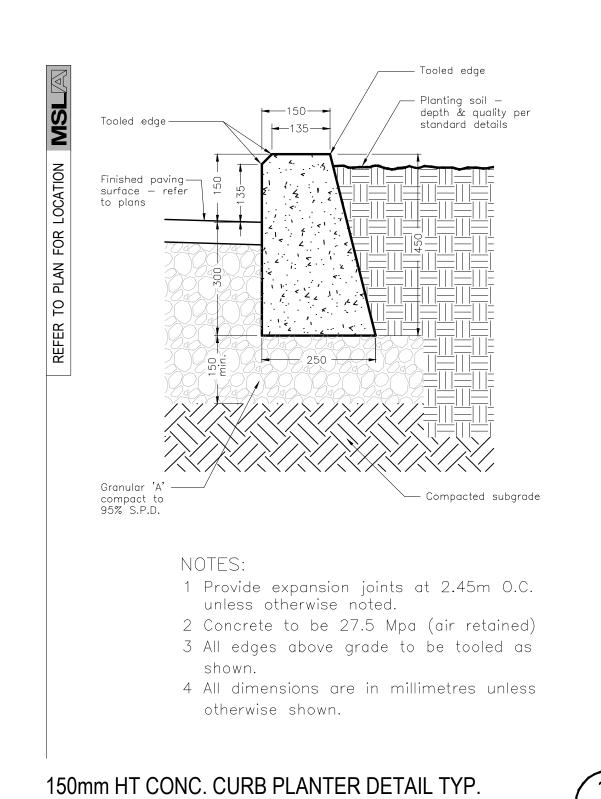
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A.L. Checked By: L.M.


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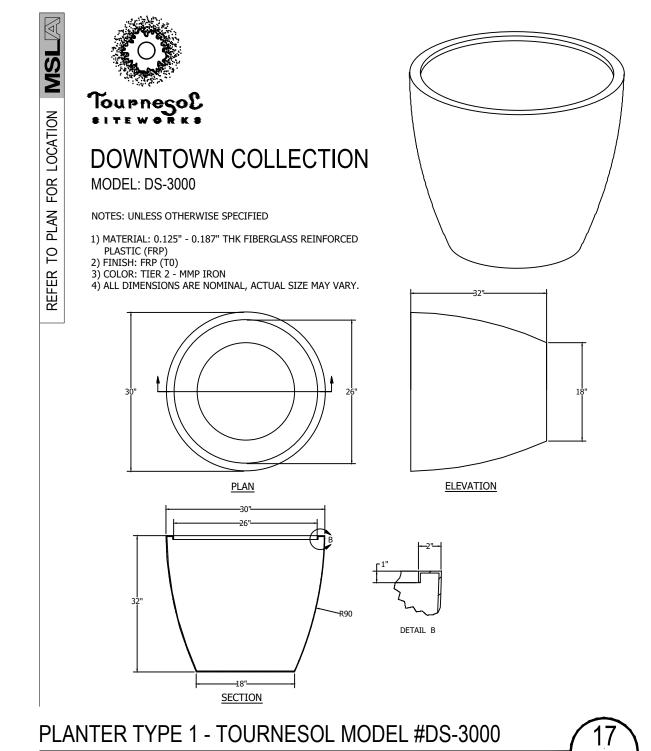
LD-02






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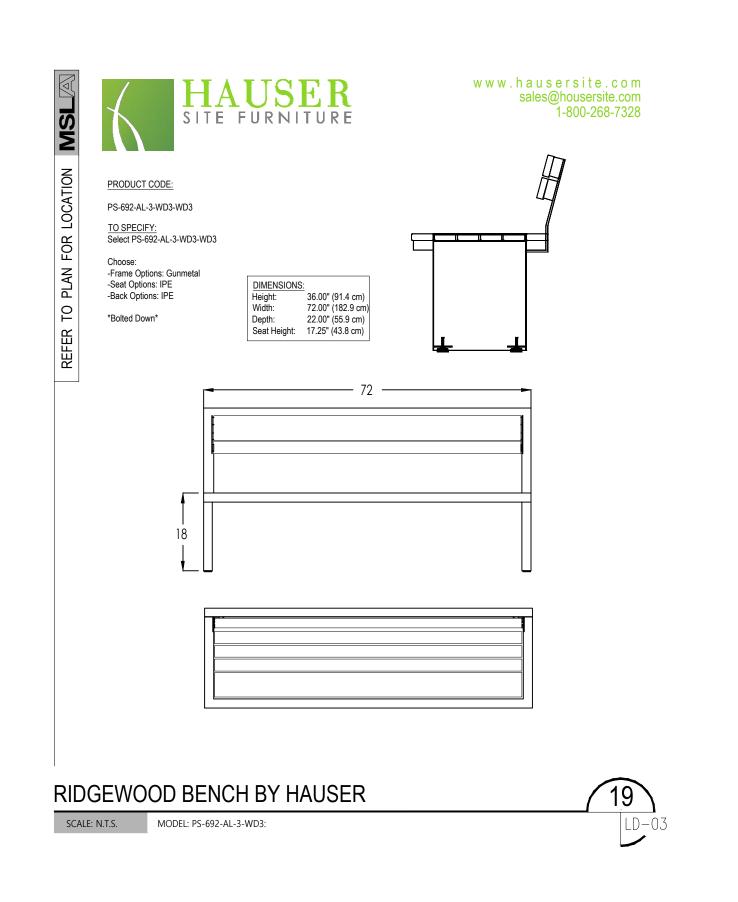


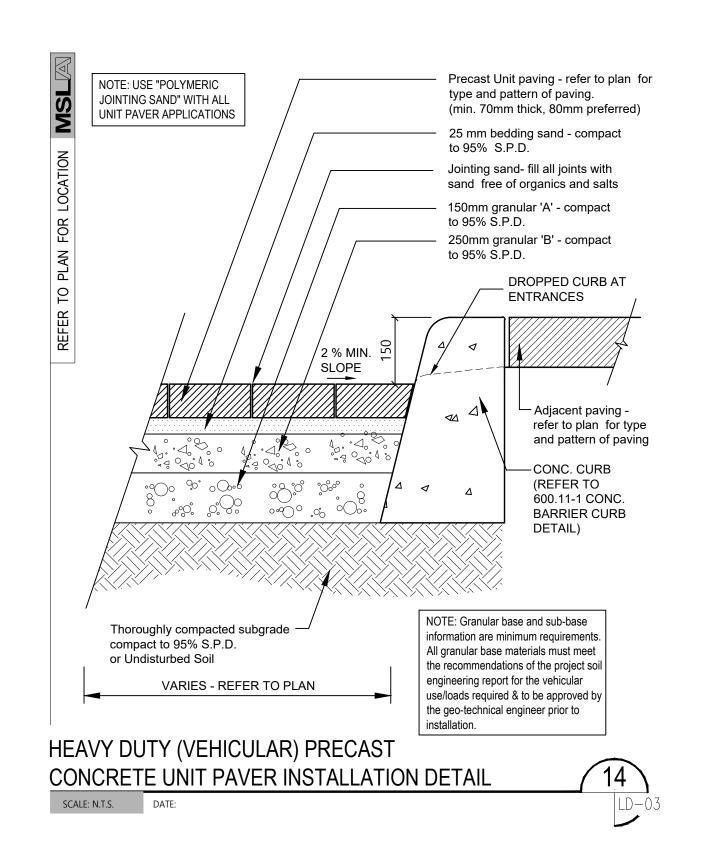MARTON SMITH LANDSCAPE ARCHITECTS

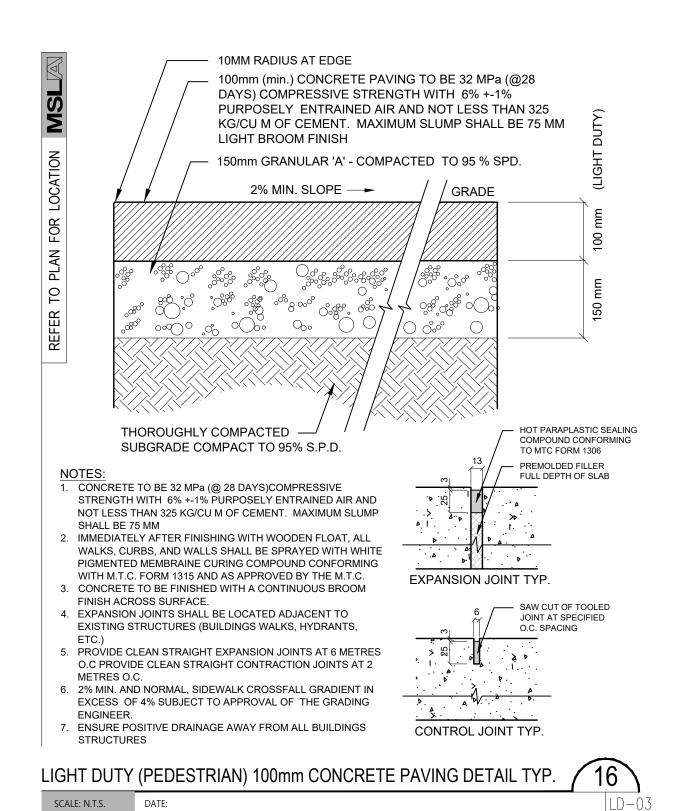


HALO STAINLESS STEEL BICYCLE RACK BY HAUSER

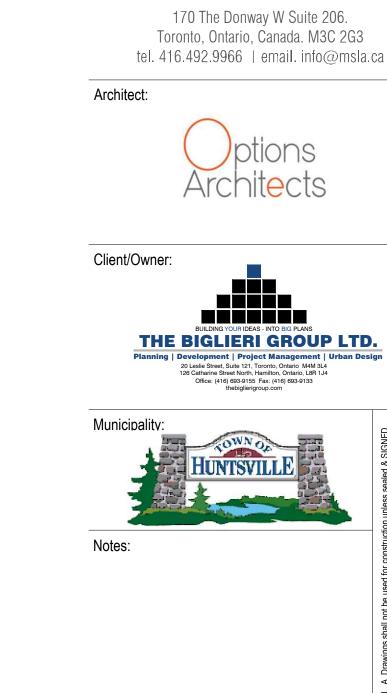SCALE: N.T.S.








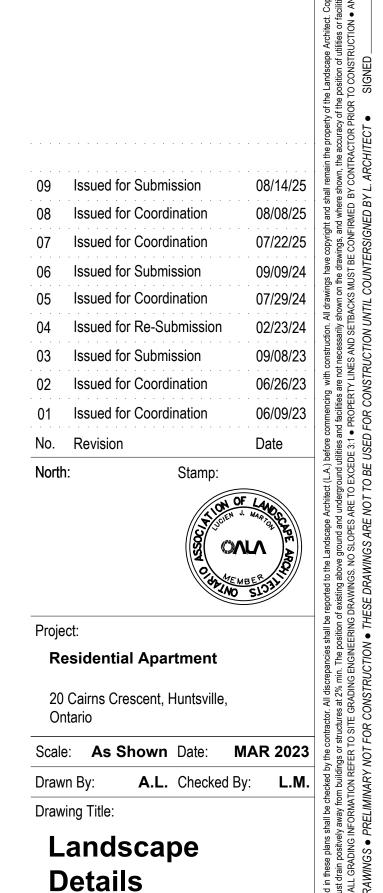

LD-03

Project No.



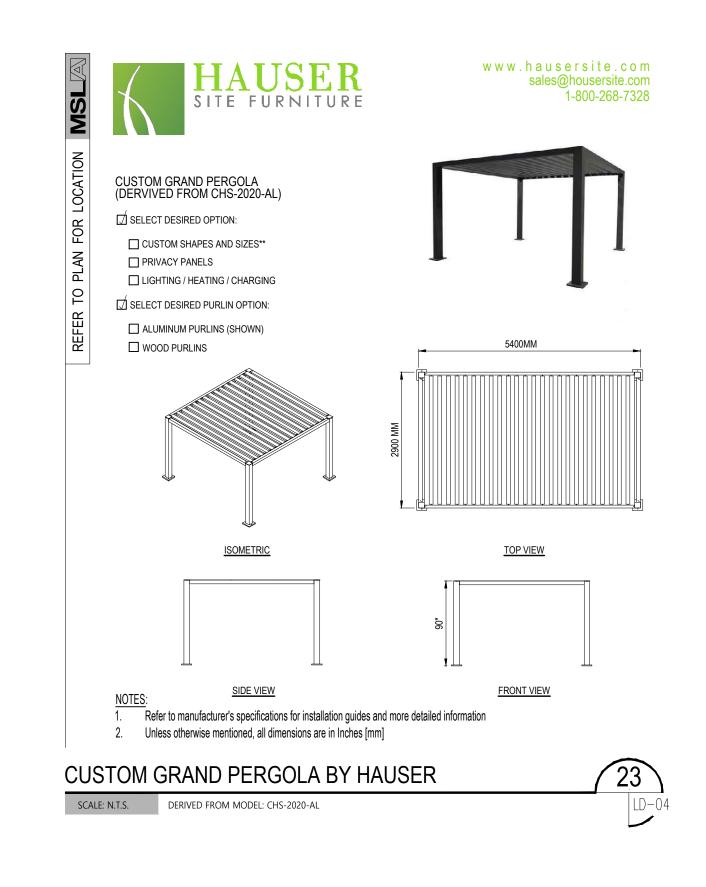




170 The Donway W Suite 206. Toronto, Ontario, Canada. M3C 2G3 tel. 416.492.9966 | email. info@msla.ca

Architect:



Client/Owner:



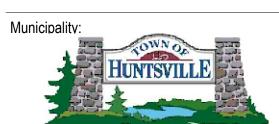

09 Issued for Submission 08 Issued for Coordination 07 Issued for Coordination 07/22/25 06 Issued for Submission 09/09/24 07/29/24 05 Issued for Coordination 04 Issued for Re-Submission 03 Issued for Submission 09/08/23 02 Issued for Coordination 06/26/23 01 Issued for Coordination No. Revision

North:



Project:

Residential Apartment

20 Cairns Crescent, Huntsville, Ontario

Scale: As Shown Date: MAR 2023 Drawn By: A.L. Checked By: L.M.

Drawing Title:

Landscape **Details**

Project No. Sheet No. 23116

LD-04